

DEPARTMENT OF VETERANS AFFAIRS MEDICAL CENTER - WADE PARK

10701 EAST BLVD. CLEVELAND, OH. 44106

Social Work and HBPC Office Renovation

PROJECT NO. 541-12-104

Veterans Administration  
Medical Center



Final Bid Set Documents  
April 27, 2012



CODE INFORMATION:

PROJECT AREA: 2,878 sf  
DESIGN CODES:  
2009 Life Safety Code, 2009 IBC  
OCCUPANCY, USE GROUP:  
Health Care, I-2  
FIRE SUPPRESSION: Fully Sprinklered  
TRAVEL DISTANCES: (LSC 18.2.5.7.3.4)  
Suite Remote Point to Exit Access Door  
One Intervening Room: 100'  
Two Intervening Rooms: 50'  
Suite Remote Point to Exit: 200'  
TYPE OF CONSTRUCTION: (LSC A.8.2.1.2)  
Type 1 - 332, 1B  
EXTERIOR BEARING WALLS: (LSC A.8.2.1.2)  
3 Hours  
INTERIOR BEARING WALLS: (LSC A.8.2.1.2)  
3 Hours  
STRUCTURAL COLUMNS: (LSC A.8.2.1.2)  
3 Hours - Supporting more than 1 floor  
2 Hours - Supporting one floor only  
2 Hours - Supporting roof only  
FLOOR - CEILING ASSEMBLIES: (LSC A.8.2.1.2)  
2 Hours  
ROOF - CEILING ASSEMBLIES: (LSC A.8.2.1.2)  
1 1/2 Hours  
INTERIOR NONBEARING WALLS: (LSC A.8.2.1.2)  
0 Hour  
EXTERIOR NONBEARING WALLS: (LSC A.8.2.1.2)  
0 Hour  
EXIT ENCLOSURES (LSC 7.1.3.2.1)  
Existing: 1 Hour  
New: 2 Hours  
SHAFT ENCLOSURES (LSC 8.6.5)  
4 Stories or more: 2 Hours  
Less than 4 stories: 1 Hour  
SMOKE BARRIERS: (LSC 18.3.6.3)  
1 Hour  
EXIT ACCESS CORRIDORS: (LSC 18.3.6.2)  
0 Hour, Smoke Partitions  
SUITE WALLS: (LSC 18.2.5.7.1.2)  
0 Hour, Smoke Partitions

DRAWING INDEX

1-X1 COVER SHEET

ARCHITECTURAL

1-01 SYMBOLS, ABBREVIATIONS, SCHEDULES & MISC. DETAILS  
1-02 PARTIAL FIRST FLOOR LIFE SAFETY & DEMO PLANS  
1-03 PARTIAL FIRST FLOOR AND REFLECTED CEILING PLANS  
1-04 INTERIOR ELEVATIONS & MILLWORK DETAILS

INTERIOR FINISHES

1-IF-01 PARTIAL FIRST FLOOR FINISH PLAN, ROOM FINISH SCHEDULE & FINISH LEGEND

FIRE PROTECTION

1-FP1 FIRE PROTECTION PLAN

PLUMBING

1-P1 PLUMBING PLAN

HVAC

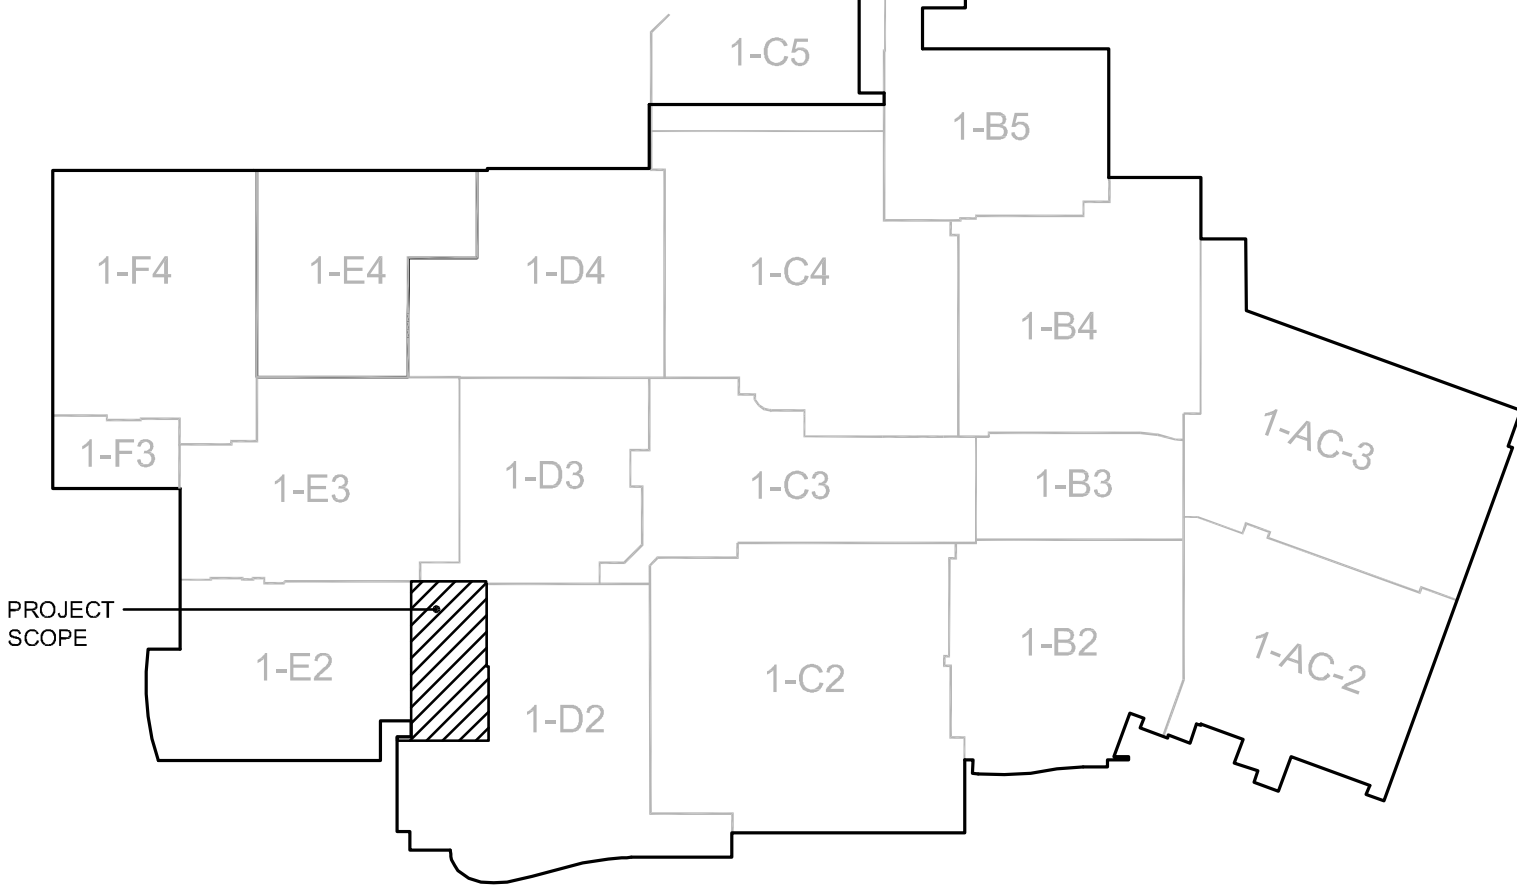
1-H1 HVAC LEGEND AND SCHEDULES  
1-H2 HVAC DETAILS  
1-H3 PARTIAL FIRST FLOOR HVAC DUCTWORK PLANS  
1-H4 PARTIAL FIRST FLOOR HVAC PIPING PLANS

ELECTRICAL

1-E1 ELECTRICAL LEGEND - SHEET 1  
1-E2 ELECTRICAL LEGEND - SHEET 2  
1-E3 LIGHTING FIXTURE SCHEDULE  
1-E4 PARTIAL FIRST FLOOR ELECTRICAL KEY PLAN  
1-E5 PARTIAL FIRST FLOOR ELECTRICAL DEMOLITION PLANS  
1-E6 PARTIAL FIRST FLOOR ELECTRICAL PLANS  
1-E7 PARTIAL FIRST FLOOR TECHNOLOGY PLAN  
1-E8 ELECTRICAL DISTRIBUTION ONE-LINE AND SCHEDULES  
1-E9 ELECTRICAL DETAILS - SHEET 1  
1-E10 ELECTRICAL DETAILS - SHEET 2  
1-E11 SECURITY SYSTEM RISER


ASBESTOS ABATEMENT

1-AA1 PARTIAL FIRST FLOOR ASBESTOS ABATEMENT PLAN  
1-AA2 STANDARD ASBESTOS ABATEMENT DETAILS



KEY PLAN - FIRST FLOOR

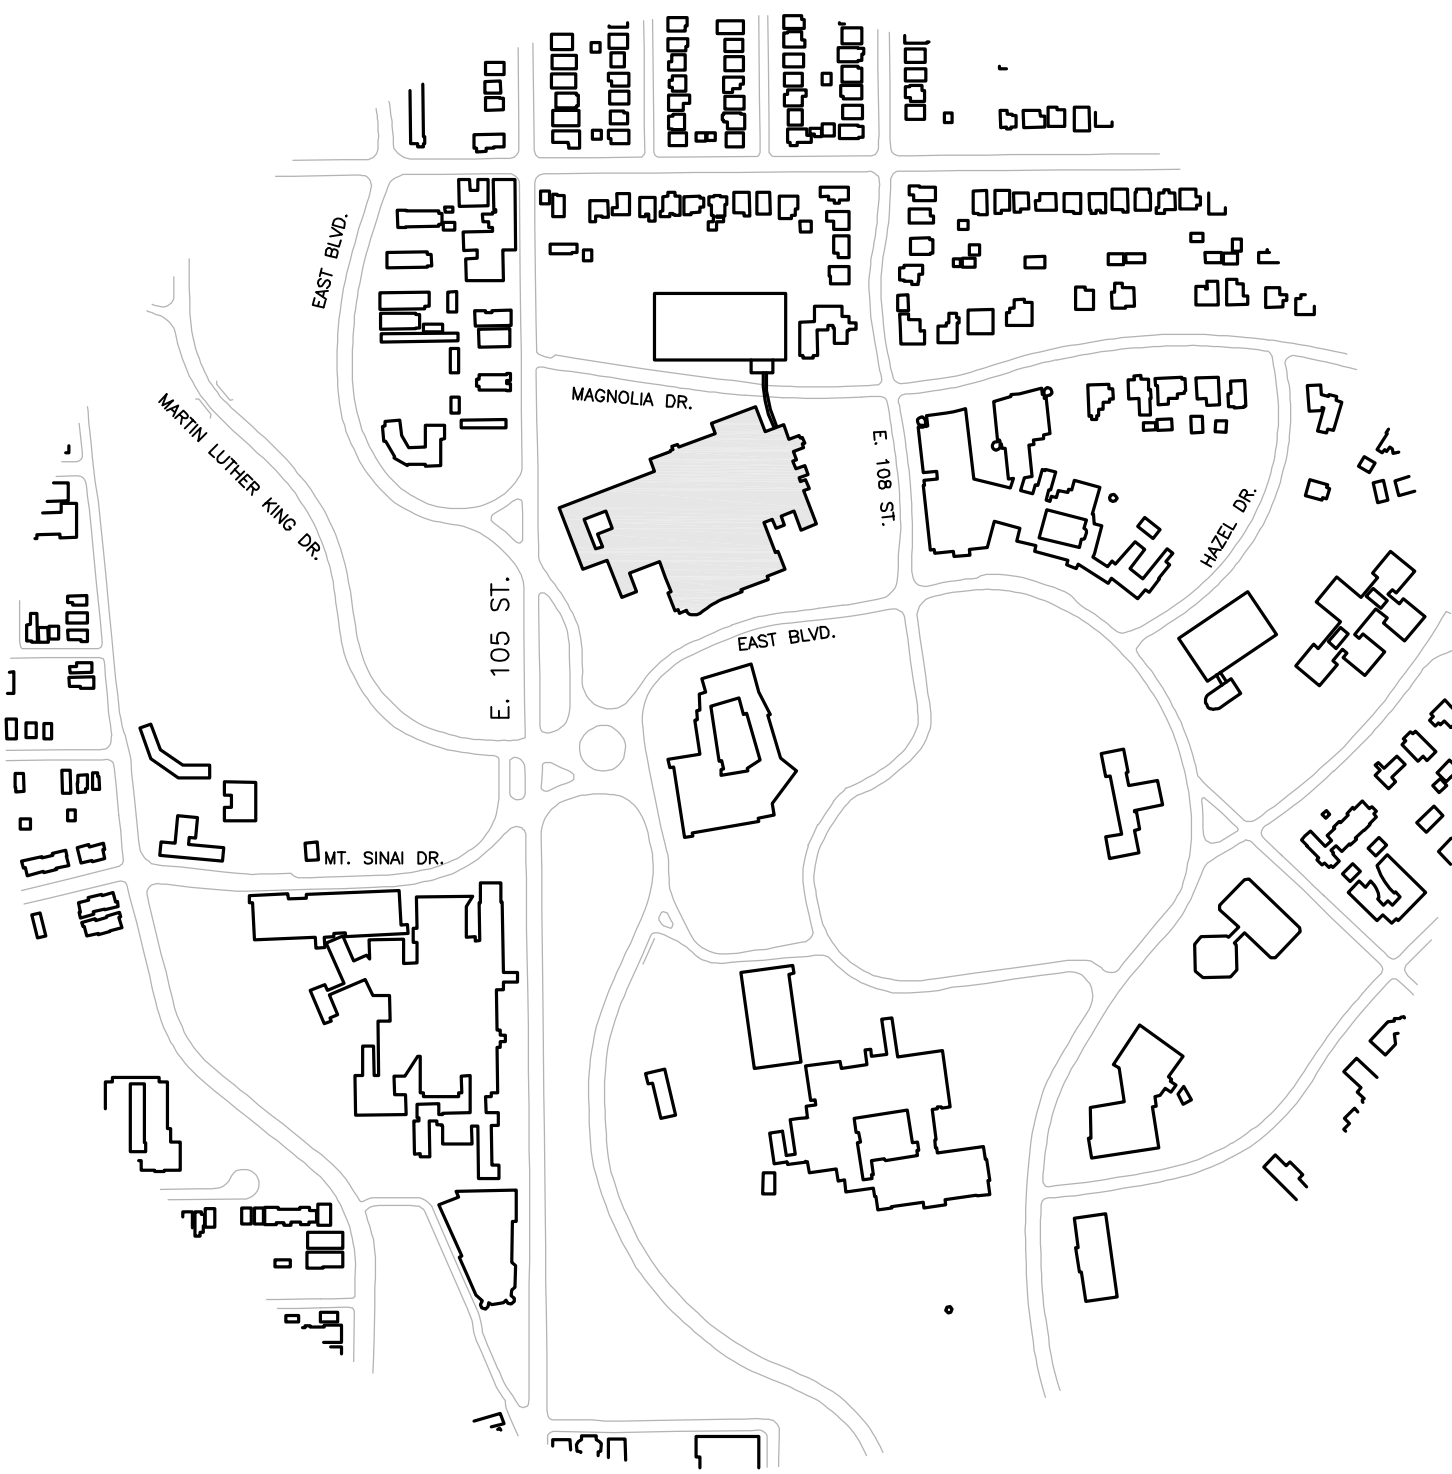Scale = None




SITE PLAN

Scale = None

ARCH. JOB NO.: 11-039

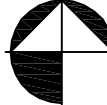NORTH



Fredrick, Fredrick & Heller Engineers

Mechanical & Electrical Engineer 672 E. Royalton Rd., Broadview Hgts, Ohio 44147

Perspectus Architecture LLC

Architect 13212 Shaker Square Suite 204 Cleveland, Ohio 44120


Stephen J. Sebesta & Associates

Asbestos Abatement 17830 Englewood Drive, Suite 16, Cleveland, Ohio 44130


FULLY SPRINKLERED

Revisions	APPROVALS		DATE		APPROVALS		DATE		APPROVALS		DATE		Drawing Title <b>COVER SHEET</b>		Project Title <b>SOCIAL WORK AND HBPC OFFICE RENOVATION</b>				Date 04-27-12		<b>Office of Facilities Management</b> 		
	DIRECTOR 00				CHIEF Planning and Construction				FACILITY MANAGER				Approved: Division Chief		Building Number 1		Checked TEH		Drawn SKA			Project No. 541-12-104	
	ASSOCIATE DIRECTOR 00A (B)				CHIEF, Occupational Health & Safety				SHOP FOREMAN 138				Approved: Service Director		Location 10701 EAST BLVD. CLEVELAND, OHIO							DRAWING NO. <b>1-X1</b>	
	CHIEF, ENGINEERING 138				CHIEF, IRM																	Dwg. Of	



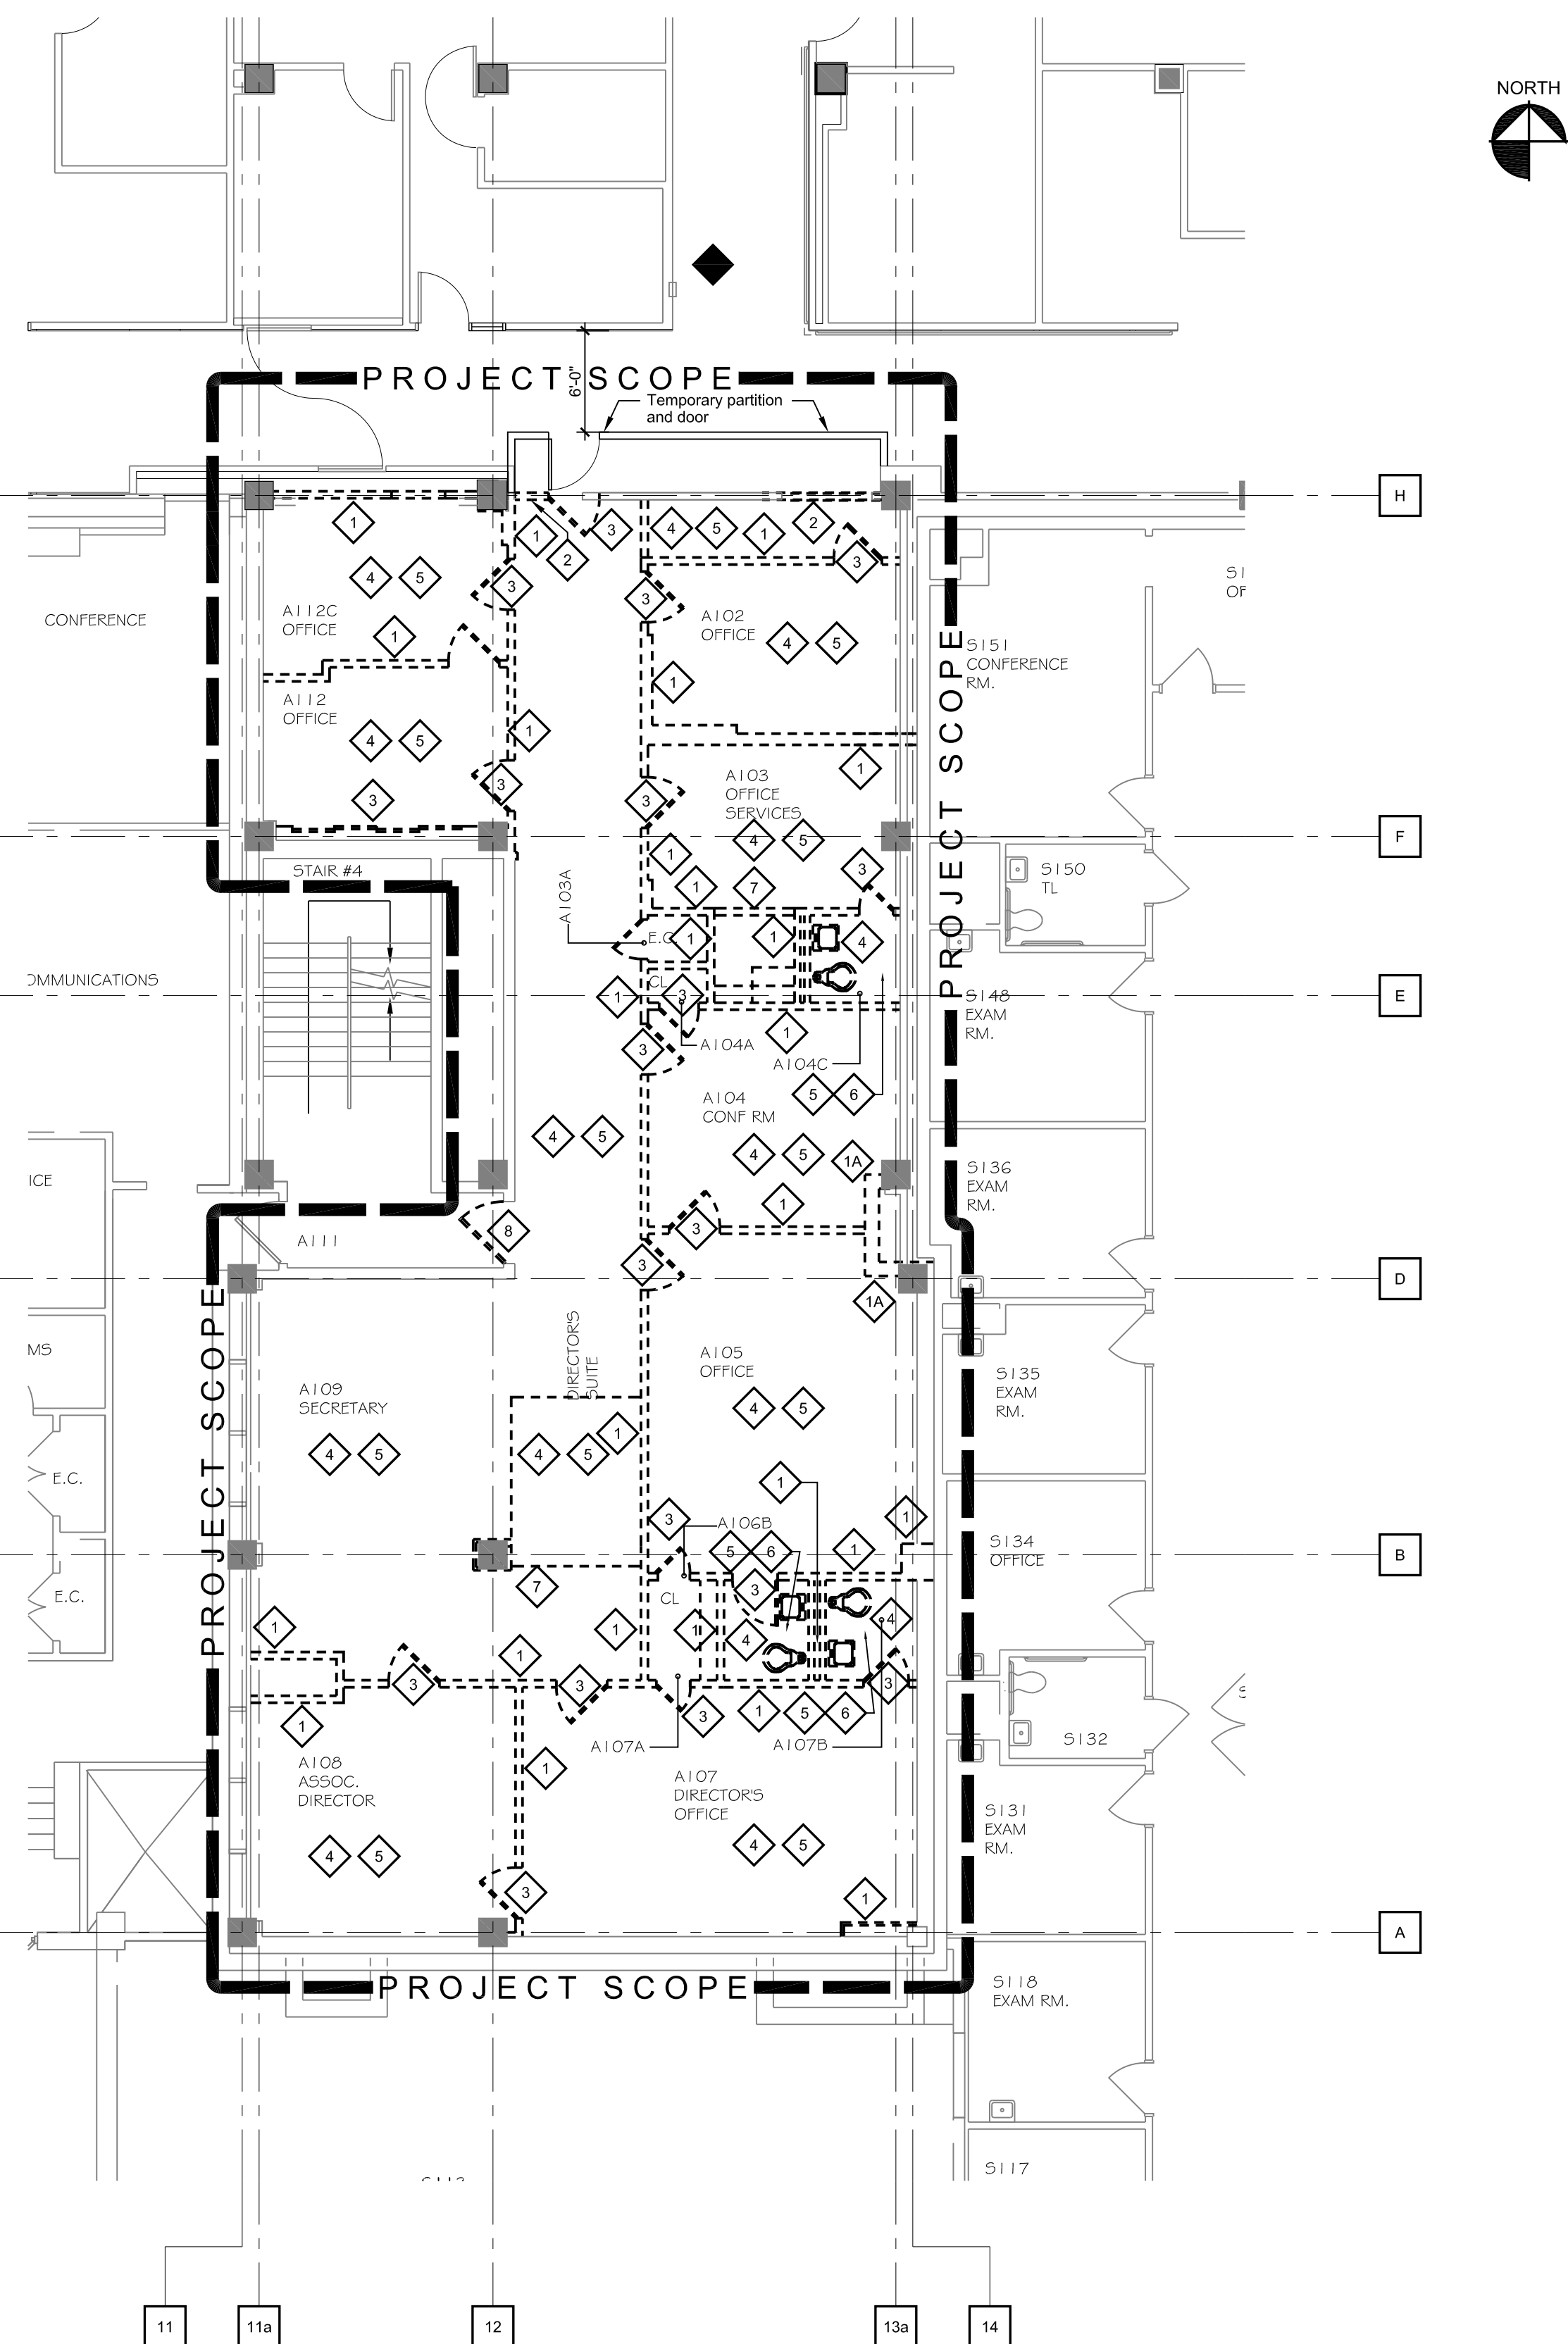

### Partial First Floor Demolition Plan

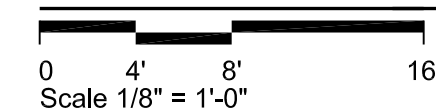

- LIFE SAFETY PLAN GENERAL NOTES

2. Contractor shall inform architect and owner immediately in writing of any discrepancies in existing rated wall construction and non-conforming penetrations.
3. Modify existing walls within project scope to be in compliance with required fire & smoke ratings. Patch openings and firestop as required for compliance. Assume 1 opening per 4 linear feet and firestopping full length of rated walls.

- DEMOLITION GENERAL NOTES CONT.

- requirements and information.
- B. Contractor shall coordinate all demolition with the entire set of contractors for full scope of demolition work required for the project.**
- C. The contractor shall verify all existing conditions, dimensions, and materials required for the project and report all discrepancies immediately to the architect.**
- D. Writing to architect prior to fabrication, erection, and/or installation.**
- E. Coordinate all new penetrations and/or openings with other associated trades.**
- F. The owner may select and tag items for demolition to be salvaged; contractor shall remove selected items from the scope of work and coordinate with owner's representative for removal.**
- G. Contractor shall provide dust proof barriers & vestibule with dust removing walk off mat (tacky mat) to separate scope of work from occupied areas.**
- H. Contractor shall provide HEPA filtered negative air machine(s) to maintain negative pressure to scope of work areas ensuring no dust will be transferred to occupied areas. Provide visual pressure monitoring and air flow monitoring to ensure proper operation. Some work may need to be monitored shall be by owner. See specification 02140 "Demolition".**
- I. The hospital's smoke and the suppression system shall remain in operation during the entire construction phase.**
- All areas will be occupied by medical center except those that are in the demolition work areas. Coordinate work areas with COTR to minimize areas that will need to be vacated. Some work may need to be performed after hours, this work will be as REGD with any additional**


6. All demolition work being done outside of temporary partitions is to be appropriately sealed off to prevent the transmission of dust and debris and minimize disruption to visitors, patients, and staff. Coordinate location and type of barriers with COTR.

- |        |   |
|--------|---|
| NOTES: | <ol style="list-style-type: none"> <li>1. Remove all existing finishes from EXIST walls to remain within project scope. Prepare all surfaces to receive scheduled finishing.</li> <li>2. See mechanical drawings for plumbing, HVAC and fire protection demolition.</li> <li>3. See electrical drawings for power, lighting and communications demotion.</li> <li>4. See structural abatement drawings for abatement work.</li> <li>5. Remove Pneumatic Tube system from entire project area.</li> </ol><br><ol style="list-style-type: none"> <li>1. Remove interior partition from floor to underside of structure above. Prepare all adjacent surfaces, including floor under removed partitions, to receive new construction and scheduled finish. All partitions to be removed that are labeled 1A are identified on existing drawings to be constructed with concrete masonry units.</li> <li>2. Remove portion of wall as required for new opening. Prepare all adjacent surfaces, including floor under removed partitions, to receive new construction and scheduled finish. Temporarily protect adjacent occupied areas until work is completed.</li> <li>3. Remove door, frame and hardware complete.</li> <li>4. Remove existing floor finish and base from entire room to top of structural slab or subfloor as required for new construction. Patch and prepare all surfaces to receive new floor finish as scheduled. Level per new floor finish manufacturer's recommendations. Patch existing walls required to receive new finish.</li> </ol> |
|--------|---|

- DEMOLITION PLAN LEGEND:

- |   |   |
|---|---|
| 5 | Remove existing ceiling system, supports, ties, and related equipment within limits of construction (unless noted otherwise). Coordinate with electrical work on removal and/or relocation of lights, conduit, ties, supports, and related wiring. Coordinate with mechanical on removal of diffusers, grilles and related ductwork and equipment. Contractor shall verify fixtures for salvage or relocation prior to commencing demolition. |
| 6 | Remove existing plumbing fixtures within limits of construction. Cap all plumbing lines not required by new construction. See plumbing plans for additional information. Remove toilet accessories within limits of demolition.   |
| 7 | Remove Bulkhead.  |
| 8 | Remove Door.  |

### LINETYPE LEGEN

 EXISTING CONSTRUCTION TO REMAIN  
EXISTING CONSTRUCTION TO BE DEMOLISHED

FULLY SPRINKLERED

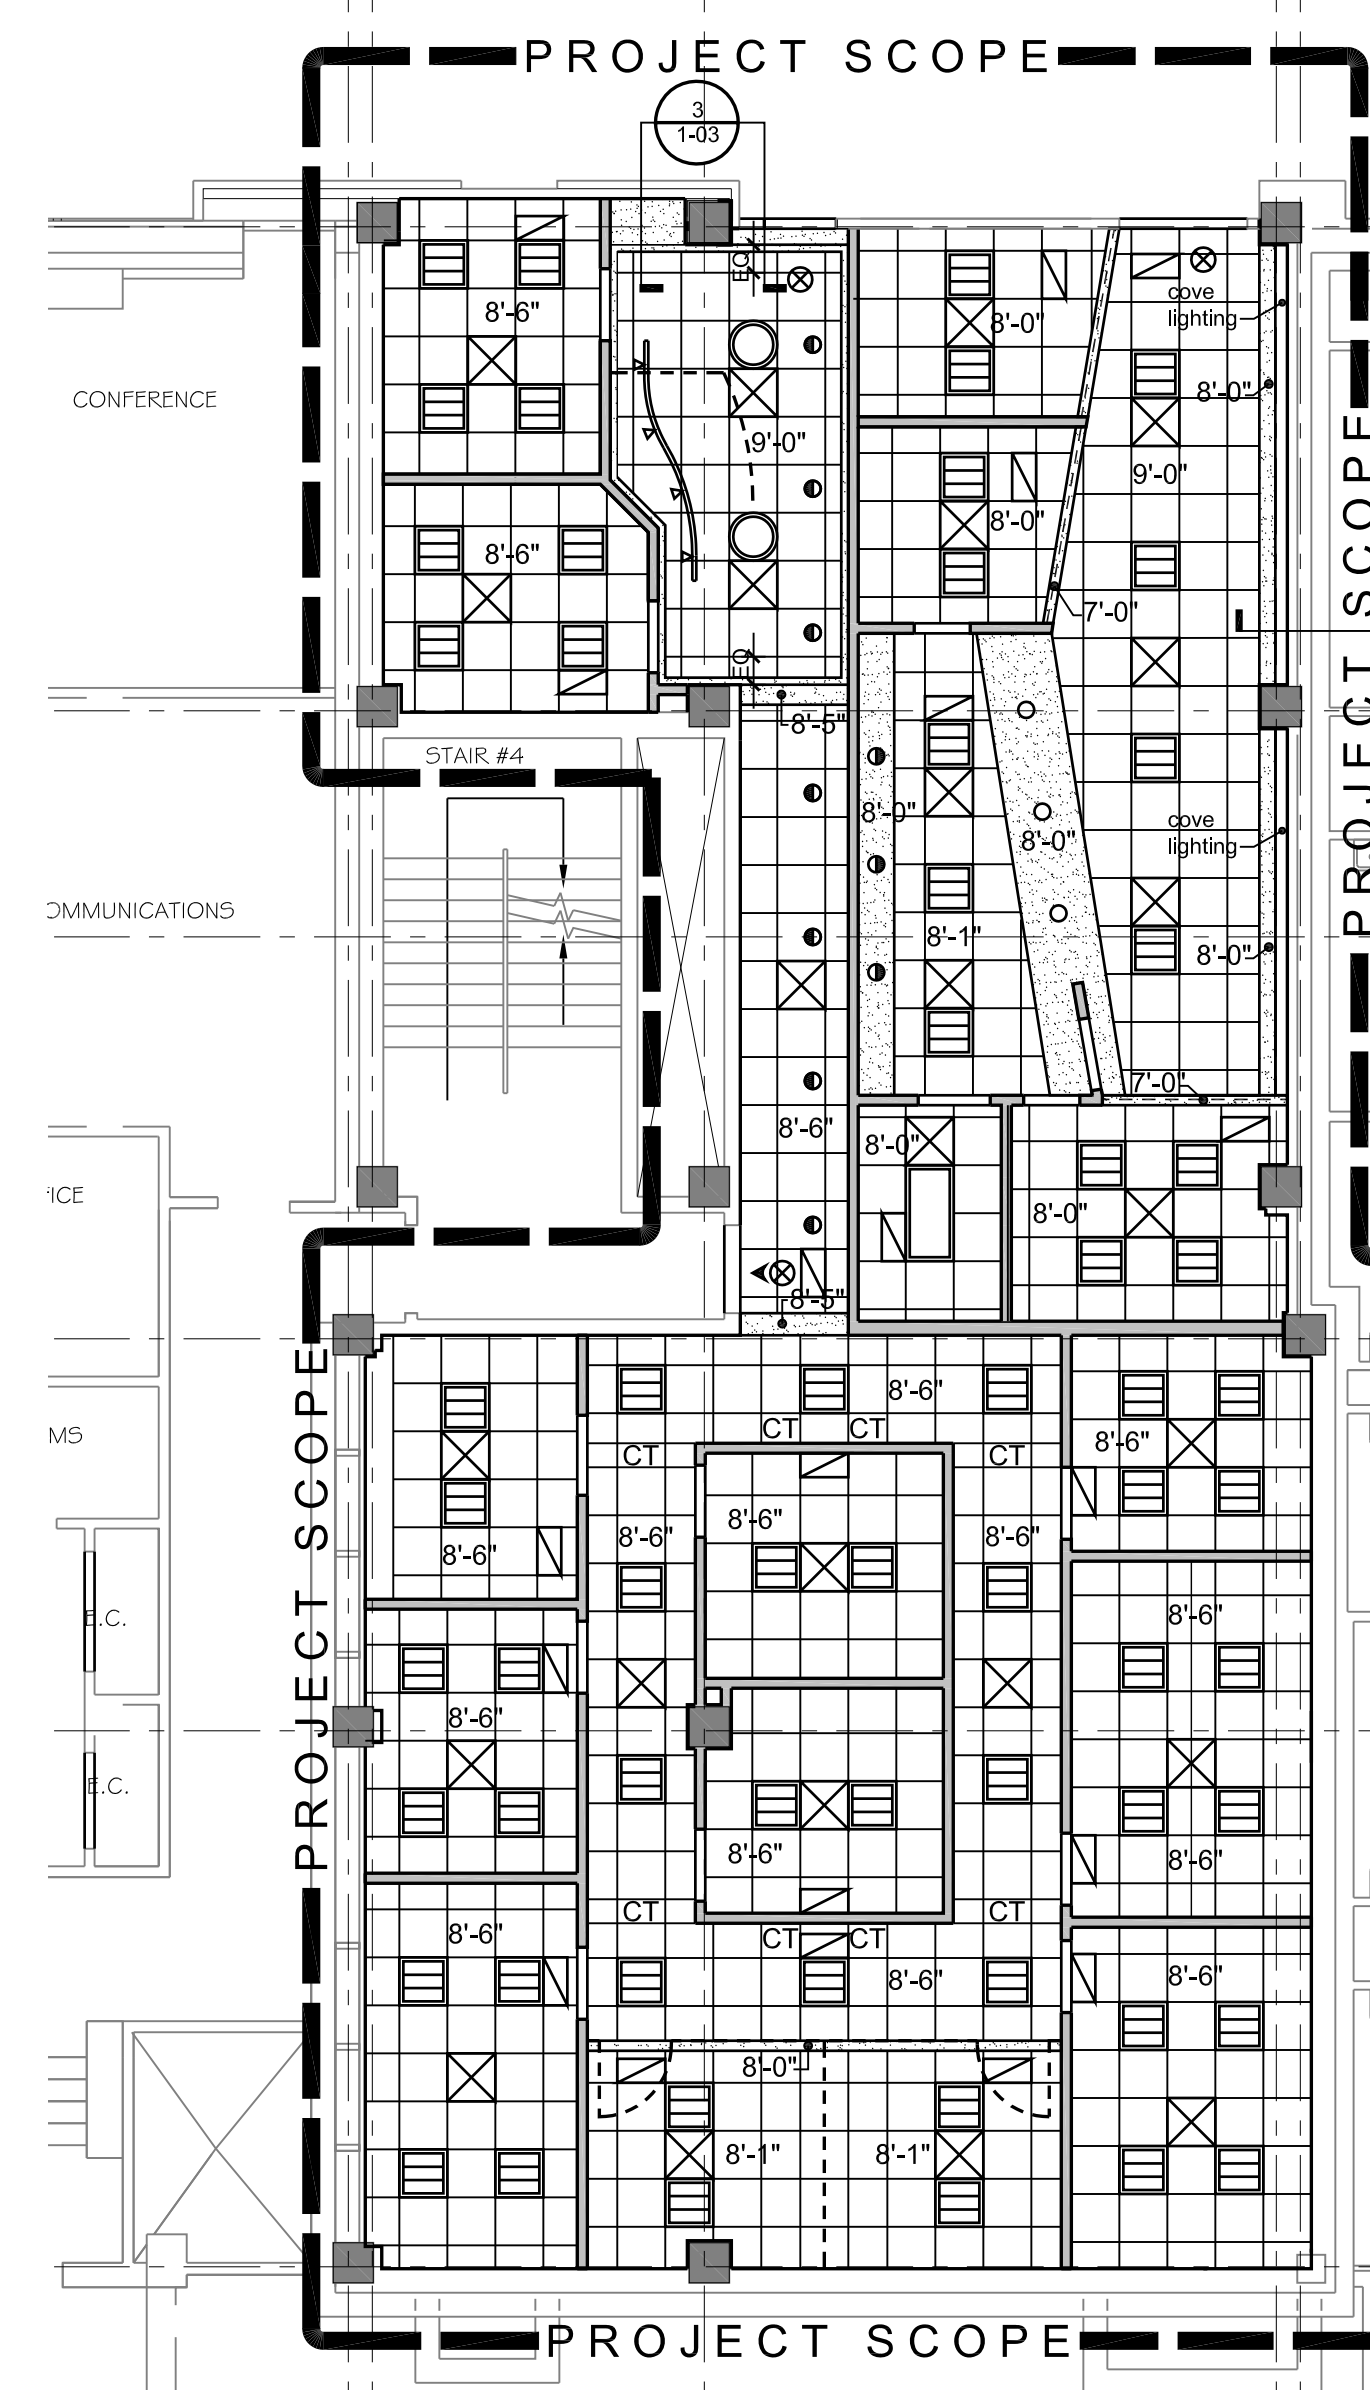
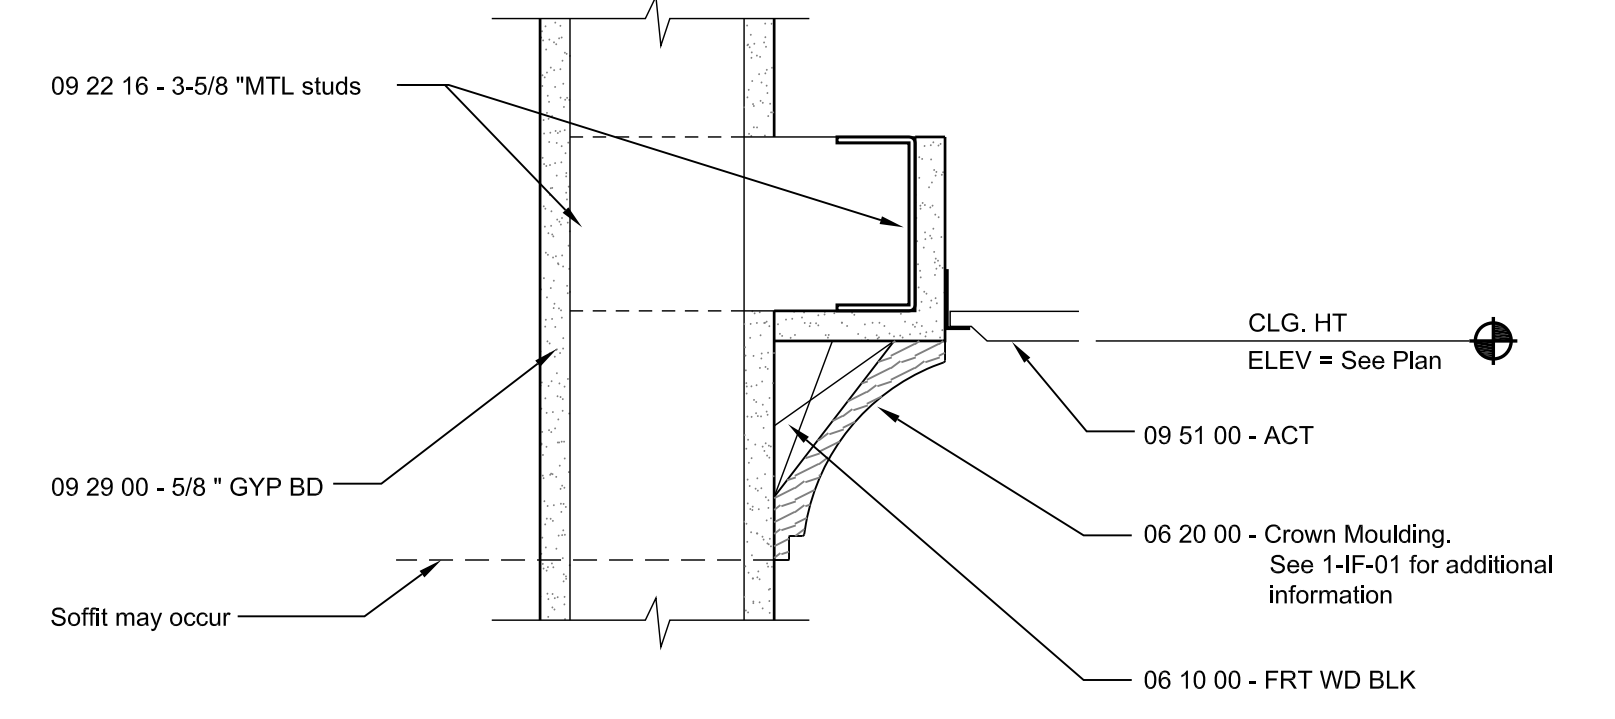
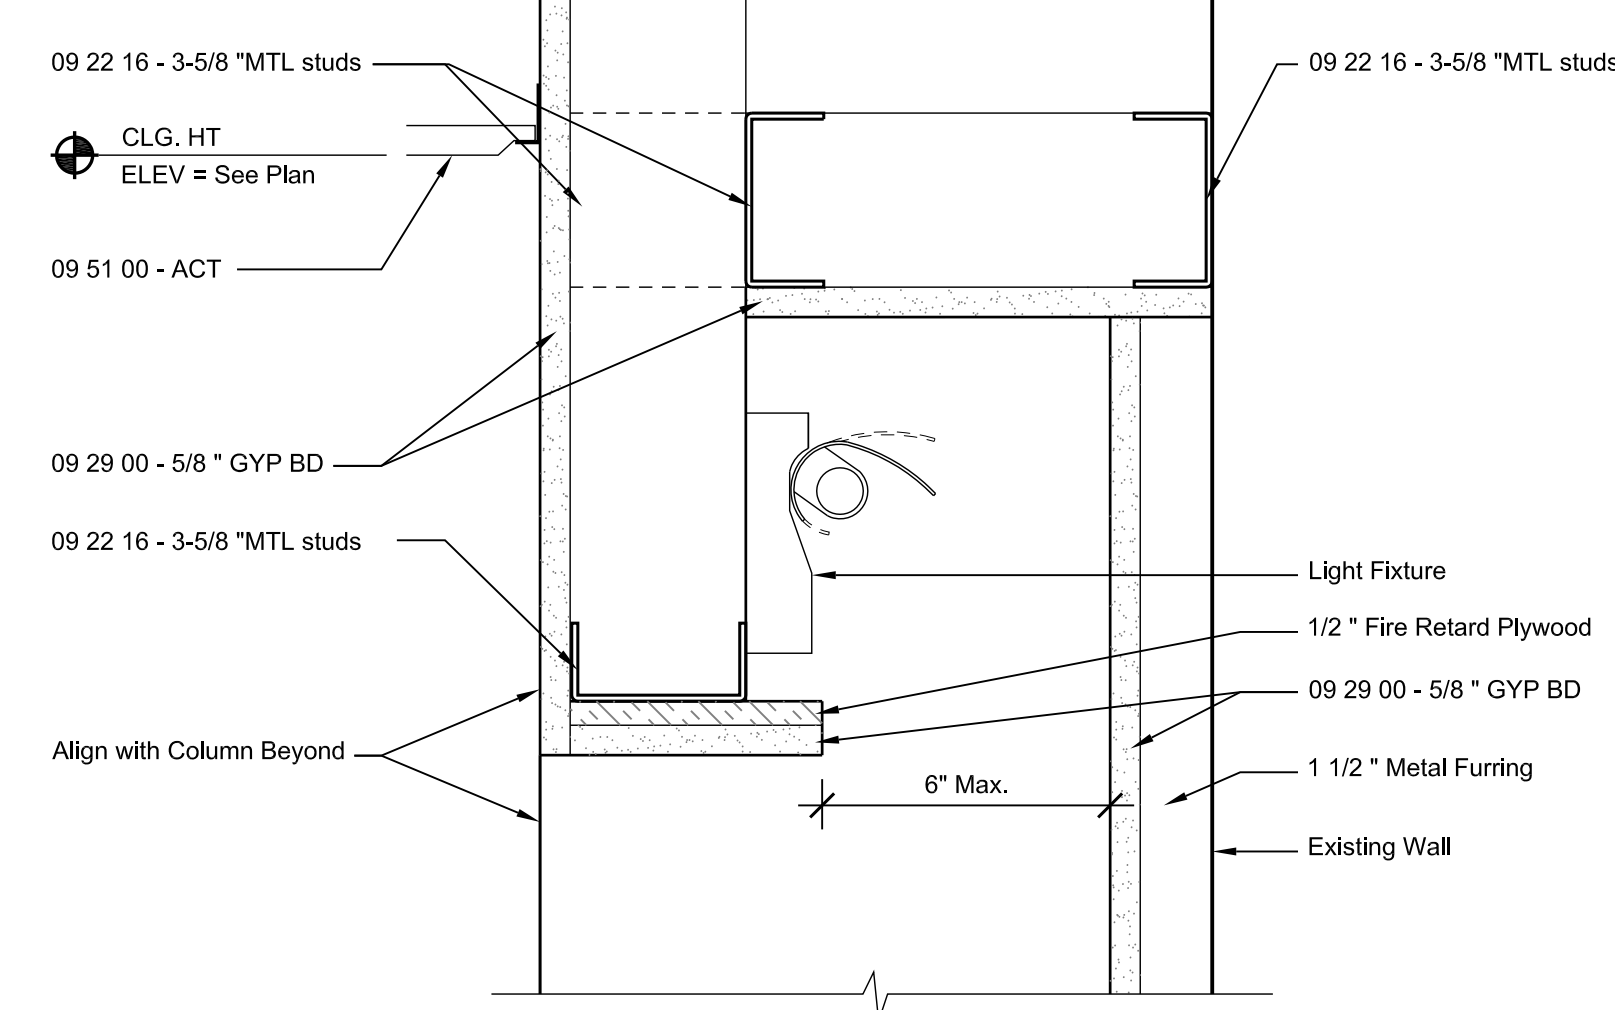
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three eighths inch = one foot  
one half inch = one foot  
one quarter inch = one foot  
one eighth inch = one foot  
one sixteenth inch = one foot

Detail  
0 4' 8' 16'  
Scale 3" = 1'-0"

Detail  
0 4' 8' 16'  
Scale 3" = 1'-0"





Partial First Floor Reflected Ceiling Plan

0 4' 8' 16'  
Scale 1/8" = 1'-0"

REFLECTED CEILING PLAN NOTES:

1. See partial first floor reflected ceiling plan for ceiling heights.
2. See specification section 09 51 00 for acoustical ceiling panel system schedule.
3. Coordinate ceiling types with Interior Finish Plan and Finish Schedule.
4. Repair or replace any ceiling tiles or repair soffits damaged in Main Street during course of construction.
5. GYP BD soffits are at 8'-0" AFF, unless noted otherwise.

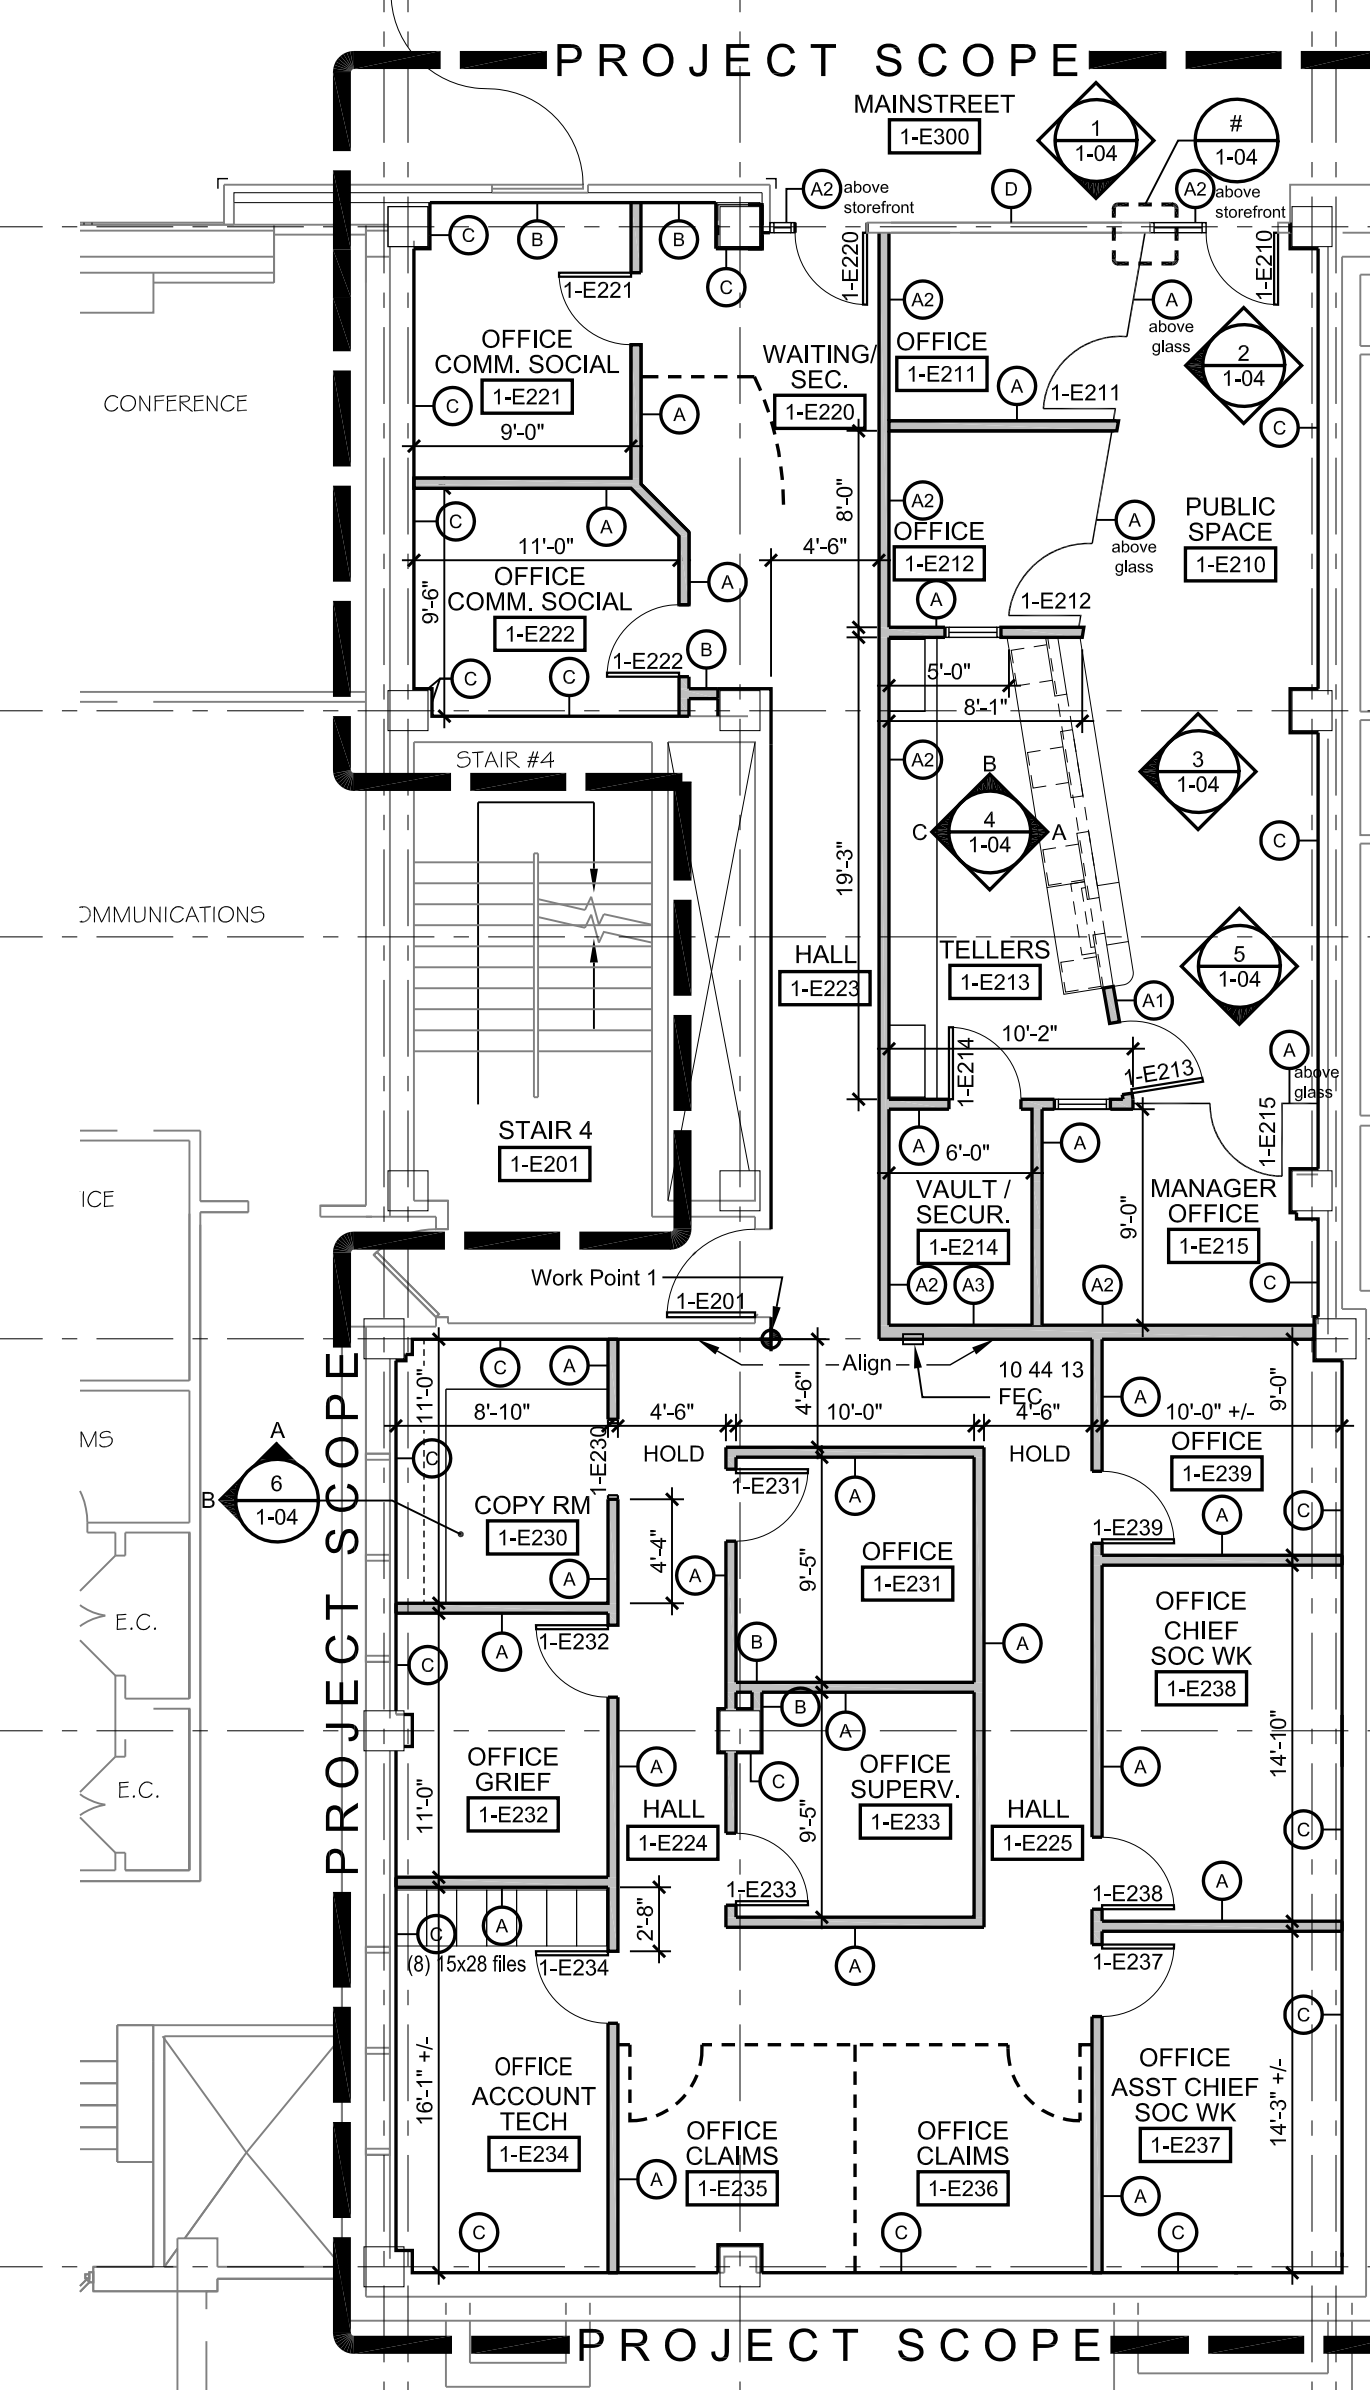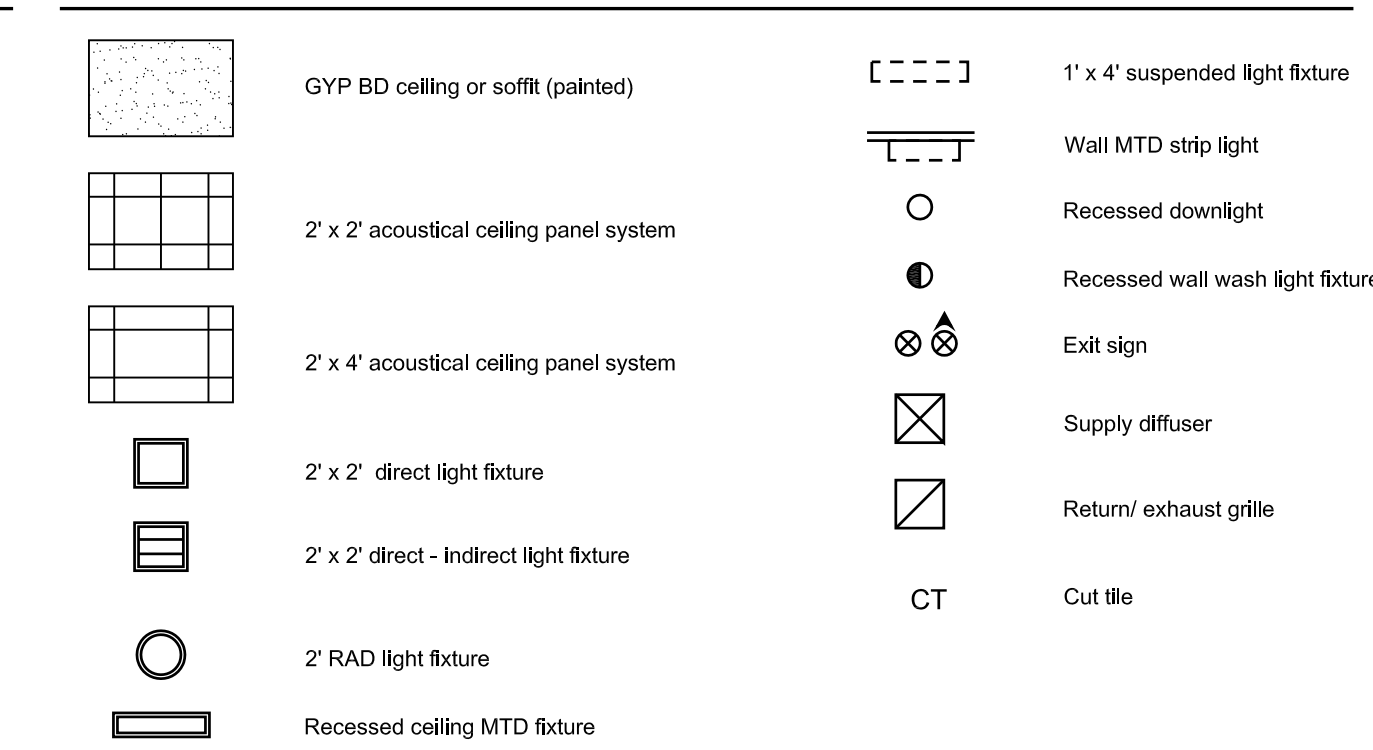REFLECTED CEILING PLAN LEGEND:



Partial First Floor Plan

0 4' 8' 16'  
Scale 1/8" = 1'-0"

GENERAL NOTES

1. All walls shall be Type A, UNO. 09 22 16 - 3 5/8" Metal Stud @ 16" OC w/ 09 29 00 - One (1) layer 5/8" GYP. BD. on finish side only, fill w/ 07 21 13 - Acoustical batt insulation (STC=48) between studs 07 86 00 - Smoke Sealant along all edges to prevent air/smoke passage. 4 1/4" NOM DIM
2. All walls shall be Type A, UNO. 09 22 16 - 3 5/8" Metal Stud @ 16" OC w/ 09 29 00 - One (1) layer 5/8" GYP. BD. on finish side only, fill w/ 07 21 13 - Acoustical batt insulation (STC=48) between studs 07 86 00 - Smoke Sealant along all edges to prevent air/smoke passage. 4 1/4" NOM DIM
3. All GYP BD will be type "X", UNO. 09 22 16 - 3 5/8" Metal Stud @ 16" OC w/ 09 29 00 - One (1) layer 5/8" GYP. BD. on finish side only, fill w/ 07 21 13 - Acoustical batt insulation (STC=48) between studs 07 86 00 - Smoke Sealant along all edges to prevent air/smoke passage. 4 1/4" NOM DIM
4. See Life Safety plan 1-02 for fire rated and smoke barriers and partitions.

WALL TYPE LEGEND

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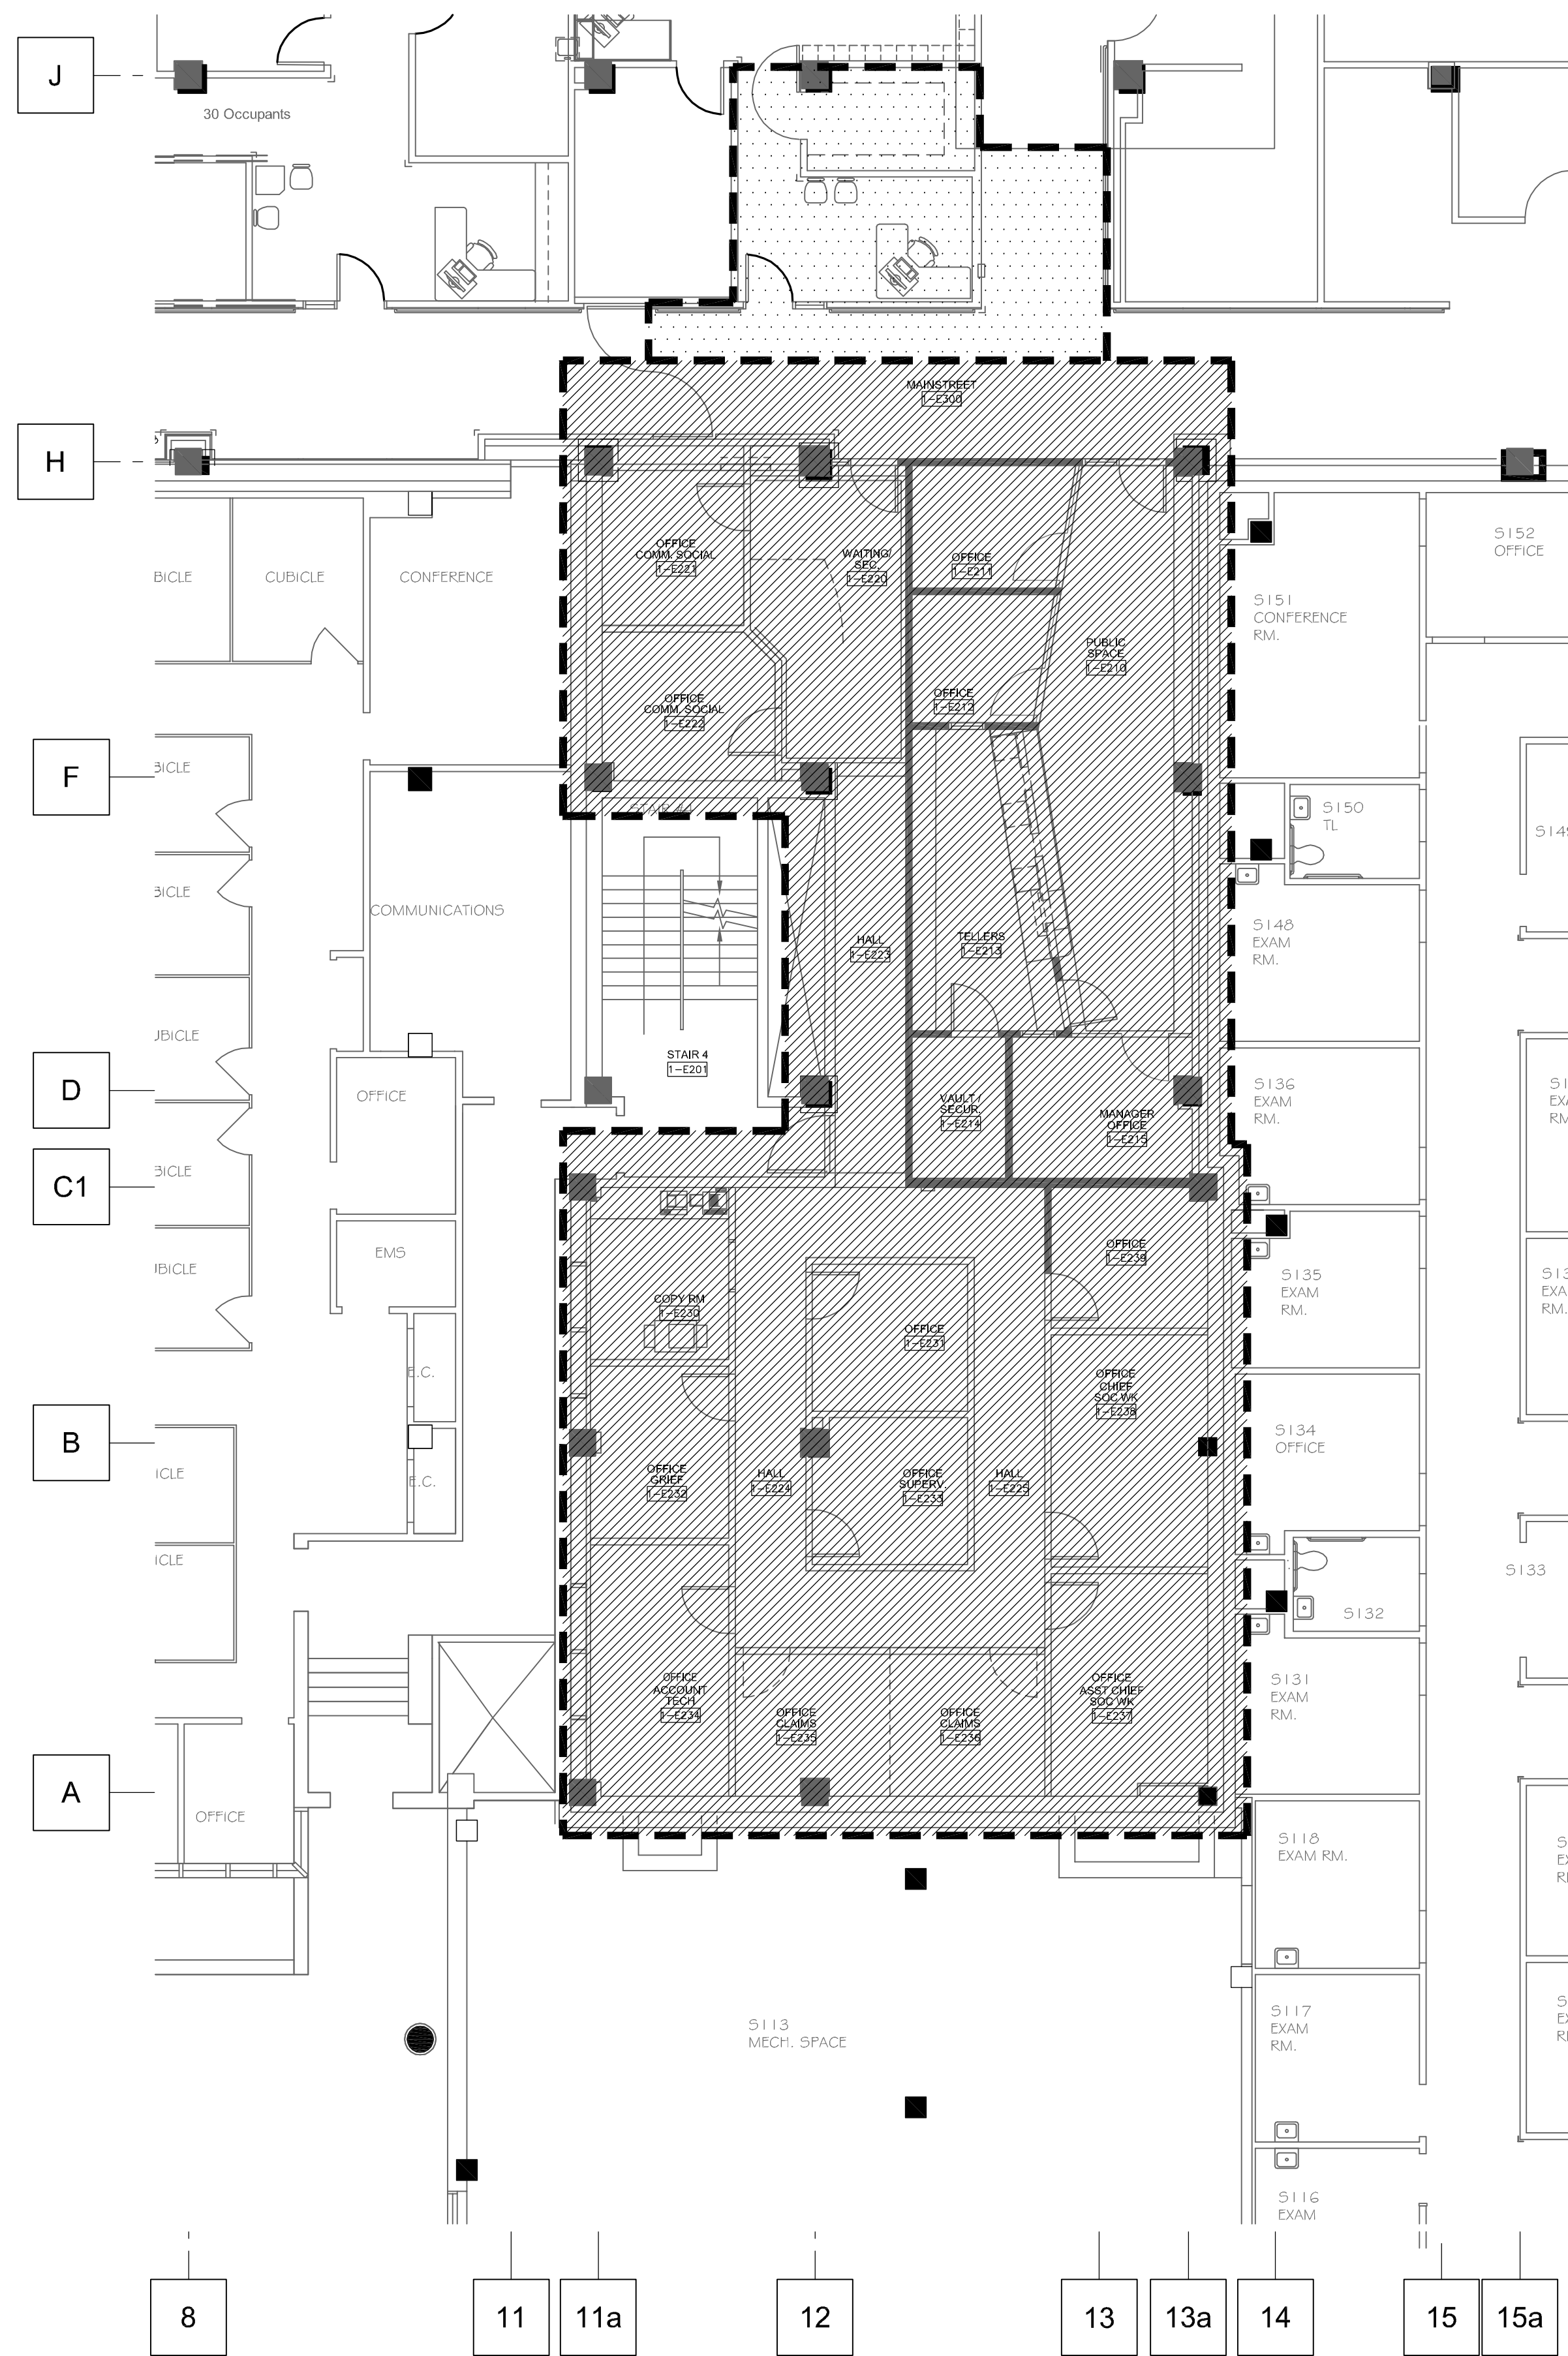
<b>CONSULTANTS:</b>  FREDRICK, FREDRICK & HELLER ENGINEERS, INC. 672 EAST ROYALTON ROAD BROADVIEW HTS., OHIO 44127 TEL: (440) 546-9696 FAX: (440) 546-9696	<b>ARCHITECT:</b>  Perspectus architecture 13212 Shaker Square Suite 204 Cleveland, Ohio 44120 P. 216.752.1800 F. 216.752.3833	Drawing Title <b>PARTIAL FIRST FLOOR AND REFLECTED CEILING PLANS</b>	Project Title <b>SOCIAL WORK &amp; HBPC OFFICE RENOVATION</b>	Project Number 541-12-104	<b>Office of Facilities Management</b>  Department of Veterans Affairs	
		Approved: Project Director	Location <b>VAMC - WADE PARK</b>	Building Number 1		
		Date 4-27-12	Checked TEH	Drawn SKA		Drawing Number <b>1-03</b>
		Dwg. of				











FIRE SUPPRESSION PIPING LEGEND

FR	FIRE SUPPRESSION PIPING
SP	FIRE RISER
FDV	STAND PIPE
EC	FIRE DEPARTMENT VALVE
HC	ELECTRICAL CONTRACTOR
FSC	HVAC CONTRACTOR
GC	FIRE SUPPRESSION CONTRACTOR
X	GENERAL CONTRACTOR
XR	EXISTING TO REMAIN
---	EXISTING TO BE REMOVED
⌵	ISOLATION VALVE
⌵	VALVED AND CAPPED FIRE DEPARTMENT VALVE
○	LIMIT OF DEMOLITION
⊕	CONNECT TO EXISTING
⊕	TAMPER SWITCH ON VALVE
⊕	FLOW SWITCH

FIRE SUPPRESSION GENERAL NOTES:

- A. LOCATIONS AND ROUTING OF EXISTING PIPING, DUCTWORK AND EQUIPMENT IS PRESUMED FROM EXISTING DRAWINGS. MECHANICAL CONTRACTOR SHALL FIELD VERIFY ALL PRIOR TO COMMENCEMENT OF CONSTRUCTION. NOTIFY ENGINEER OF ANY CONDITIONS WHICH WILL NOT PERMIT THE WORK TO BE PERFORMED AS INDICATED ON THESE DRAWINGS.
- B. COORDINATE ALL SHUT-DOWNS OF EXISTING SYSTEMS WITH OWNER A MINIMUM OF TEN WORKING DAYS IN ADVANCE.
- C. PRIOR TO INSTALLATION, VERIFY PRECISE LOCATION OF NEW WALL MOUNTED DEVICES WITH OWNER AND ARCHITECT. REFER TO ARCHITECTURAL REFLECTED CEILING PLAN FOR PRECISE LOCATION OF CEILING MOUNTED DEVICES.
- D. PROVIDE ADEQUATE SERVICE CLEARANCE FOR ALL EQUIPMENT. REFER TO INSTRUCTIONS FROM THE EQUIPMENT MANUFACTURER.
- E. NEW PIPING SHALL NOT BE ROUTED ABOVE ELECTRICAL PANELS. REFER TO ELECTRICAL DRAWINGS FOR LOCATION OF PANELS.
- F. THE FIRE SUPPRESSION CONTRACTOR SHALL PROVIDE DETAILED DESIGN OF THE SPRINKLER SYSTEM. REFER TO SPECIFICATIONS.
- G. UNLESS OTHERWISE NOTED NEW SPRINKLERS SHALL BE AS FOLLOWS:  
G.1. AREAS WITH CEILINGS: RECESSED CONCEALED STYLE WITH COVER PLATES.  
G.2. EXPOSED STRUCTURE: UPRIGHT OR PENDENT TYPE.
- H. ALL SPRINKLERS FURNISHED AS PART OF THIS PROJECT SHALL HAVE COVER PLATES WITH THE SAME SHAPE AND SIZE. COLOR SHALL BE REVIEWED BY ARCHITECT.
- I. THE FIRE PROTECTION SYSTEM IS PERFORMANCE SPECIFIED. ALL SPRINKLER PIPE SIZES SHALL BE DETERMINED BY FIRE PROTECTION CONTRACTOR, BASED ON HYDRAULIC CALCULATIONS.
- J. CONTRACTOR IS RESPONSIBLE TO SUBMIT THEIR FIRE PROTECTION SHOP DRAWINGS TO OWNERS INSURANCE UNDERWRITER AND LOCAL FIRE MARSHAL AND OBTAIN APPROVAL PRIOR TO STARTING WORK.
- K. PROVIDE SUPPLEMENTAL DRAINS AS NECESSARY TO PROVIDE 100% SYSTEM DRAINAGE. LOCATE DRAINS ABOVE ACCESSIBLE CEILINGS.
- L. REFER TO ARCHITECTURAL PLANS FOR EXACT PHASING REQUIREMENTS.
- M. REFER TO SPECIFICATIONS FOR FIRE SUPPRESSION HAZARD OCCUPANCY CLASSIFICATIONS.
- N. SPRINKLER PIPING SHALL BE A MINIMUM OF ONE INCH.
- O. UNLESS OTHERWISE STATED ON DRAWINGS OR IN THE SPECIFICATIONS, ALL SPRINKLER HEADS SHALL BE QUICK RESPONSE.
- P. ALL SPRINKLER HEADS LOCATED IN CEILING TILES SHALL BE CENTERED IN TILE.
- Q. ALL SPRINKLER ZONES SHALL MATCH SMOKE COMPARTMENTS. REFER TO ARCHITECTURAL PLANS FOR INFORMATION ON SMOKE COMPARTMENTS, SMOKE PARTITIONS AND FIRE BARRIERS.
- R. CONTRACTOR SHALL REMOVE AND REPLACE CEILING TILES AND GRID AS REQUIRED TO COMPLETE DEMOLITION AND NEW WORK IN AREAS OUTSIDE OF RENOVATION PROJECT. CONTRACTOR SHALL BE RESPONSIBLE FOR REPLACING ANY TILES OR GRID DAMAGED DUE TO THIS WORK.

ALL OUTLINED AREAS SHALL BE 100% FULLY SPRINKLERED WITH A WET-TYPE SPRINKLER SYSTEM IN ACCORDANCE WITH NFPA 13 AND VA SPECIFICATIONS. SPRINKLER HEADS SHALL BE INSTALLED SO AS TO ACCOMMODATE ANY NEW CEILINGS. COORDINATE SPRINKLER HEAD LAYOUT WITH ARCHITECTURAL REFLECTED CEILING PLAN. REFER TO MECHANICAL SPECIFICATIONS AND FIRE SUPPRESSION NOTES FOR ADDITIONAL INFORMATION.

FIRE SUPPRESSION LEGEND

- REMOVE EXISTING SPRINKLER MAIN AND BRANCH PIPING AND SPRINKLER HEADS SERVING OUTLINED AREA. PROVIDE ALL NEW MAIN AND BRANCH PIPING AND SPRINKLER HEADS IN OUTLINED AREA. COORDINATE PIPING INSTALLATION WITH ALL OTHER TRADES. REWORK EXISTING MAIN PIPING SERVING ADJACENT AREAS AS REQUIRED. PROVIDE RECESSED, CONCEALED SPRINKLER HEADS WITH WHITE COVER PLATES IN ROOMS WITH CEILINGS. PROVIDE NEW UPRIGHT, PENDENT-TYPE SPRINKLER HEADS IN AREAS WITH EXPOSED STRUCTURE. COORDINATE INSTALLATION OF HEADS WITH ARCHITECTURAL REFLECTED CEILING PLAN.
- REWORK EXISTING SPRINKLER MAIN AND BRANCH PIPING IN OUTLINED AREA TO ACCOMMODATE REMOVAL/INSTALLATION OF HVAC SYSTEMS. PROVIDE NEW SPRINKLER HEADS IN AREAS WHERE EXISTING CEILINGS ARE BEING REMOVED/REPLACED. COORDINATE CEILING REMOVAL/REPLACEMENT WITH ALL CONTRACTORS. SPRINKLER HEADS SHALL MATCH THOSE IN EXISTING CEILINGS.

PARTIAL FIRST FLOOR FIRE PROTECTION PLAN

SCALE: 1/8" = 1'-0"

1

Final Bid Set Documents	4-27-12
Revisions:	Date

CONSULTANTS:

FREDRICK, FREDRICK & HELLER  
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672 EAST ROYALTON ROAD  
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FAX: (440) 546-0606



ARCHITECT:

Perspectus  
architecture

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P. 216.752.1800 F. 216.752.3833

DESIGN AND CONSTRUCTION DOCUMENTS AS INSTRUMENTS OF SERVICE ARE GIVEN IN CONFIDENCE AND REMAIN THE PROPERTY OF PERSPECTUS ARCHITECTURE. THE USE OF THIS DESIGN AND THESE CONSTRUCTION DOCUMENTS FOR PURPOSES OTHER THAN THE SPECIFIC PROJECT NAMED HEREIN IS STRICTLY PROHIBITED WITHOUT THE EXPRESSED WRITTEN CONSENT OF PERSPECTUS ARCHITECTURE.

Drawing Title  
FIRE PROTECTION PLAN

Approved: Project Director

Project Title  
SOCIAL WORK AND  
HBPC OFFICE  
RENOVATION

Location  
VAMC - WADE PARK

Date  
04-27-12

Checked  
LDH

Drawn  
SEP

Project Number  
541-12-104

Building Number  
1

Drawing Number  
1-FP1


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FULLY SPRINKLERED

Office of  
Facilities  
Management

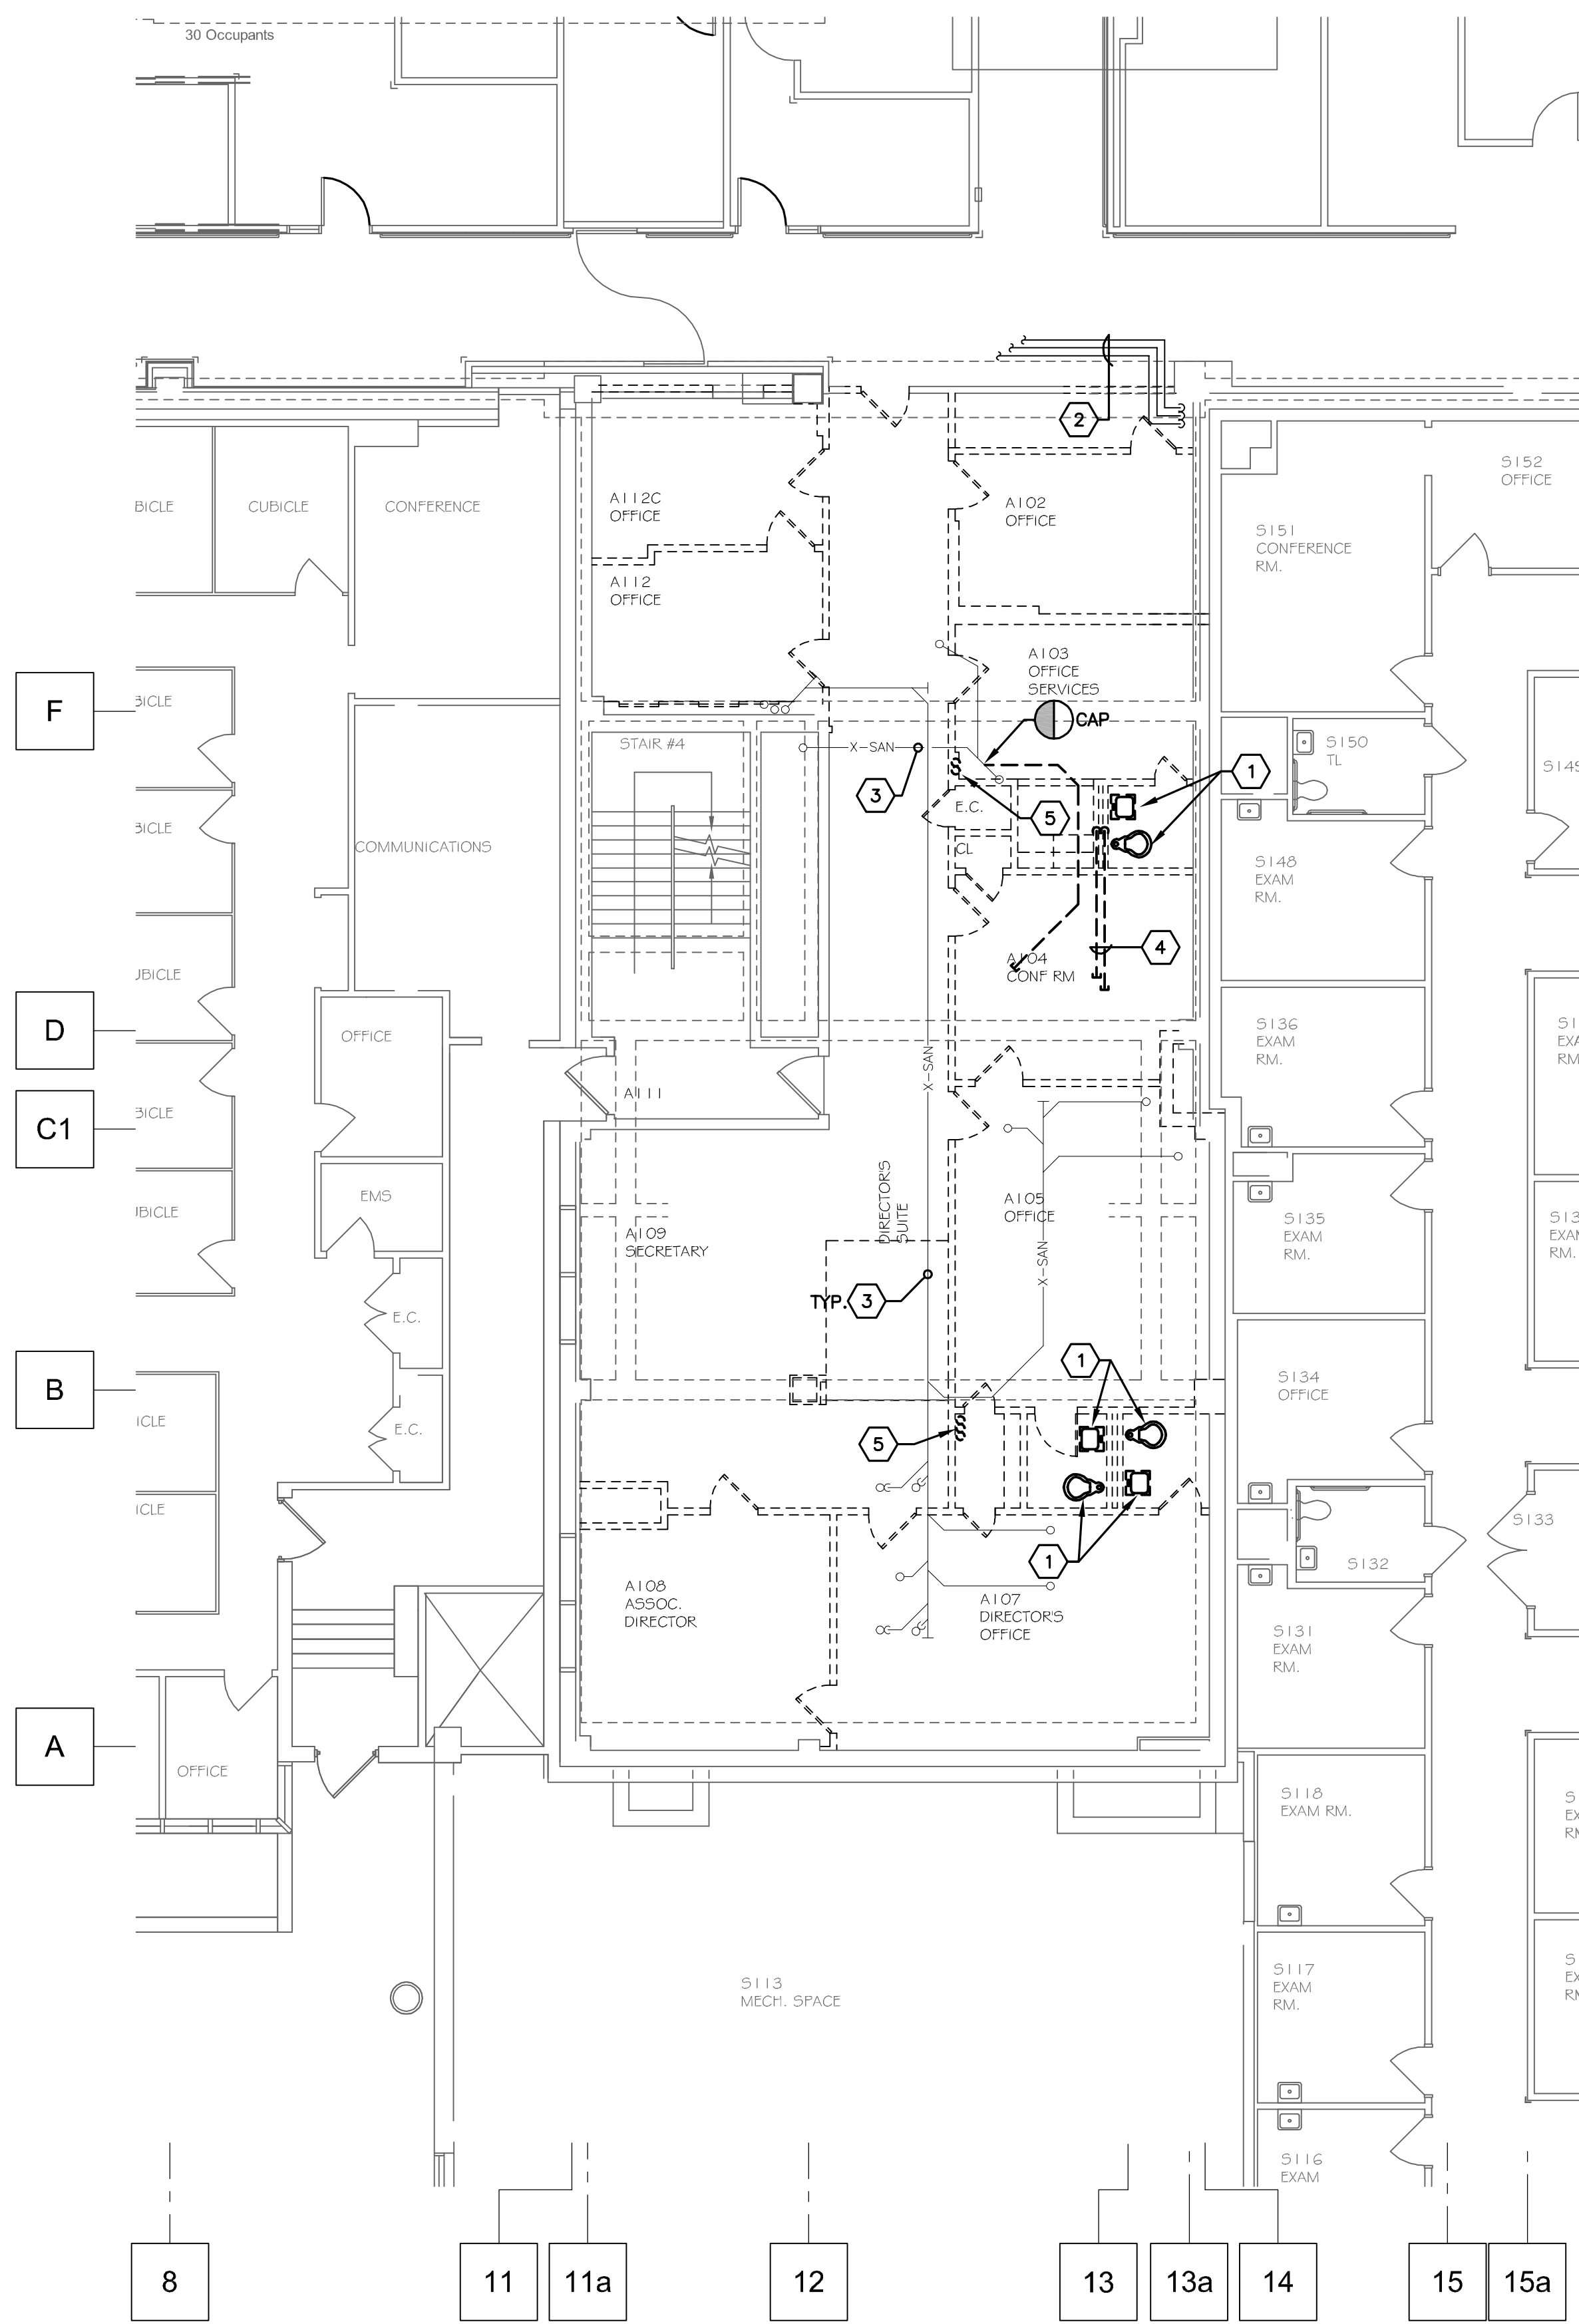Department of  
Veterans Affairs





PLUMBING SYMBOLS:

- ① REFERENCE TO CODED NOTE
- VTR VENT THROUGH ROOF
- PC PLUMBING CONTRACTOR
- GC GENERAL CONTRACTOR
- ST— STORM WATER PIPING
- OST— STORM OVERFLOW PIPING
- SAN— SANITARY WASTE
- V— PLUMBING VENT
- CW— DOMESTIC COLD WATER SUPPLY
- HW— DOMESTIC HOT WATER SUPPLY
- HWR— DOMESTIC HOT WATER RETURN
- FD FLOOR DRAIN
- X— EXISTING TO REMAIN
- XR--- EXISTING TO BE REMOVED
- XRL--- EXISTING TO BE RELOCATED
- ⋈ ISOLATION VALVE
- LIMIT OF DEMOLITION
- ⊕ CONNECT TO EXISTING

PLUMBING GENERAL NOTES:

- A. LOCATIONS AND ROUTING OF EXISTING PIPING, DUCTWORK AND EQUIPMENT IS PRESUMED FROM EXISTING DRAWINGS. MECHANICAL CONTRACTOR SHALL FIELD VERIFY ALL PRIOR TO COMMENCEMENT OF CONSTRUCTION. NOTIFY ENGINEER OF ANY CONDITIONS WHICH WILL NOT PERMIT THE WORK TO BE PERFORMED AS INDICATED ON THESE DRAWINGS.
- B. COORDINATE ALL SHUT-DOWNS OF EXISTING MECHANICAL SYSTEMS WITH OWNER A MINIMUM OF TEN WORKING DAYS IN ADVANCE.
- C. PRIOR TO INSTALLATION, VERIFY PRECISE LOCATION OF NEW WALL MOUNTED DEVICES WITH OWNER AND ARCHITECT.
- D. PROVIDE ADEQUATE SERVICE CLEARANCE FOR ALL MECHANICAL EQUIPMENT. REFER TO INSTRUCTIONS FROM THE EQUIPMENT MANUFACTURER.
- E. NEW PIPING SHALL NOT BE ROUTED ABOVE ELECTRICAL PANELS. REFER TO ELECTRICAL DRAWINGS FOR LOCATION OF PANELS.
- F. WHERE EXISTING FIXTURES ARE TO BE REMOVED, REMOVE ALL ASSOCIATED BRANCH PIPING WHICH IS NOT TO BE REUSED. REMOVE PIPING TO MAINS AND CAP.
- G. CONTRACTOR SHALL REMOVE AND REPLACE CEILING TILES AND GRID AS REQUIRED TO COMPLETE DEMOLITION AND NEW WORK IN AREAS OUTSIDE OF RENOVATION PROJECT. CONTRACTOR SHALL BE RESPONSIBLE FOR REPLACING ANY TILES OR GRID DAMAGED DUE TO THIS WORK.
- H. CONTRACTOR SHALL PROVIDE NEW CHASE ENCLOSURES WHERE EXISTING STORM, SANITARY, WATER, VENT RISERS ARE TO REMAIN, BUT ARE UNCOVERED/EXPOSED DURING CONSTRUCTION. ENCLOSURES SHALL FULLY CONCEAL PIPING. COORDINATE REQUIREMENTS WITH GENERAL TRADES.

CODED NOTES:

- ① REMOVE EXISTING PLUMBING FIXTURE AND ALL ASSOCIATED SANITARY, VENT, CW, AND HW PIPING BACK TO ACTIVE MAINS AND CAP. SANITARY, CW, AND HW PIPING MAINS ARE LOCATED BELOW. FILL AND PATCH ALL HOLES IN THE FLOOR AS NECESSARY.
- ② EXISTING 2" CW, 1" HW, AND 3/4" HWR TO REMAIN. REWORK PIPING AS REQUIRED TO ACCOMMODATE NEW SYSTEMS.
- ③ APPROXIMATE ROUTING OF EXISTING SANITARY MAIN AND BRANCH PIPING IS SHOWN (ABOVE CEILING). CONTRACTOR SHALL REWORK PIPING AS REQUIRED TO ACCOMMODATE NEW SYSTEMS.
- ④ EXISTING ABANDONED WATER PIPING TO BE REMOVED BACK TO ACTIVE MAIN AND CAPPED. FILL AND PATCH HOLES IN FLOOR AS NECESSARY.
- ⑤ EXISTING ABANDONED WATER RISERS CONCEALED IN WALL TO BE REMOVED. CAP BACK AT ACTIVE MAINS. FILL AND PATCH HOLES IN FLOOR AS NECESSARY. COORDINATE REMOVAL WITH VA FACILITIES PERSONNEL.

PARTIAL FIRST FLOOR  
PLUMBING DEMOLITION PLAN

SCALE: 1/8" = 1'-0"

0' 4' 8' 16' 32'

1

		<b>CONSULTANTS:</b>		<b>ARCHITECT:</b>		Drawing Title <b>PLUMBING PLAN</b>		Project Title <b>SOCIAL WORK AND HBPC OFFICE RENOVATION</b>		Project Number 541-12-104		<b>Office of Facilities Management</b>			
		 FREDRICK, FREDRICK & HELLER ENGINEERS, INC. 672 EAST ROYALTON ROAD BROADVIEW HTS., OHIO 44147 TEL. (440) 546-0606 FAX. (440) 546-0606		 BRIAN WIDOWSKI 66625 Professional Engineer		Approved: Project Director		Location <b>VAMC - WADE PARK</b>		Building Number 1				Drawing Number <b>1-P1</b> Dwg. of	
Final Bid Set Documents Revisions:		4-27-12 Date		13212 Shaker Square Suite 204 Cleveland, Ohio 44120 P. 216.752.1800 F. 216.752.3833				Date 04-27-12		Checked LDH		Drawn SEP			



## VAV TERMINALS

MARK	MAX. AIRFLOW (CFM)	MIN. AIRFLOW (CFM)	TERMINAL TYPE (NOTE 2)	HOT WATER HEATING COIL PERFORMANCE				
				CAPACITY (MBH)	COIL FLOW (GPM)	AIR TEMP. RISE (°F)	WATER PRES. DROP (FT.)	NUMBER OF ROWS
VAV-1	200	100	A	3.8	0.3	35	0.10	1
VAV-2	200	200	A	7.6	0.5	35	0.10	2
VAV-3	200	100	A	3.8	0.3	35	0.10	1
VAV-4	575	400	B	15.2	0.8	35	0.15	2
VAV-5	115	60	A	2.3	0.25	35	0.10	1
VAV-6	300	150	A	5.7	0.3	35	0.15	1
VAV-7	115	60	A	2.3	0.25	35	0.10	1
VAV-8	200	100	A	3.8	0.3	35	0.10	1
VAV-9	350	175	A	6.6	0.3	35	0.15	1
VAV-10	215	100	A	3.8	0.3	35	0.10	1
VAV-11	115	60	A	2.3	0.25	35	0.10	1

### VAV TERMINAL NOTES:

- REFER TO SPECIFICATIONS FOR ADDITIONAL INFORMATION.
- TERMINALS SHALL BE CAPABLE OF OPERATING WITH A MINIMUM INLET PRESSURE OF 0.5 IN. W.G. PROVIDE WITH SCREW ACCESS (UN-HINGED) WHERE TERMINALS ARE INSTALLED IN THE BEAM/JOIST SPACE.
- REFER TO "VARIABLE AIR VOLUME TERMINALS: CONNECTION SCHEDULE" FOR TERMINAL SIZE, DUCT CONNECTIONS AND DUCT SIZES.

## VARIABLE AIR VOLUME TERMINALS : CONNECTION SCHEDULE

TERMINAL TYPE	INLET		MAX. AIRFLOW (CFM)	TERMINAL AIR PRESSURE DROP (IN W.G.)	RADIATED NOISE (NC)	DISCHARGE	
	TERMINAL NECK SIZE (IN)	SUPPLY DUCT (IN)				TERMINAL CONN. SIZE (IN)	DISCHARGE DUCT (IN)
A	6"ø	8"ø	350	1.0"	25	12x8	10x10
B	8"ø	10"ø	700	1.0"	27	12x10	16x12

### NOTES:

- PROVIDE DUCT SIZES AS INDICATED OR EQUIVALENT FREE AREA AS INDICATED ON PLANS.
- CONTRACTOR SHALL PROVIDE ALL TRANSITIONS/OFFSETS AS NECESSARY.

## AIR DISTRIBUTION DEVICE (DIFFUSERS, REGISTERS AND GRILLES)

MARK	TYPE	FACE SIZE (INCHES)	NECK SIZE (INCHES)	STYLE	COLOR	MATERIAL	FACTORY DAMPER	NOTES
S1	SUPPLY DIFFUSER	24x24	SEE TAG	PLAQUE FACE LAY-IN	WHITE	ALUMINUM	-	1
S2	SUPPLY DIFFUSER	12x12	SEE TAG	PLAQUE FACE LAY-IN	WHITE	ALUMINUM	-	1,2
R1	RETURN GRILLE	24x12	SEE TAG	PERFORATED FACE LAY-IN	WHITE	ALUMINUM	-	1
R2	RETURN GRILLE	24x24	SEE TAG	PERFORATED FACE LAY-IN	WHITE	ALUMINUM	-	1

### NOTES:

- REFER TO SPECIFICATIONS FOR ADDITIONAL INFORMATION.
- PROVIDE 24"x24" LAY-IN PANEL.

## MECHANICAL SYMBOLS:

### ABBREVIATIONS:

AD	ACCESS DOOR
AFF	ABOVE FINISHED FLOOR
AHU	AIR HANDLING UNIT
AP	ACCESS PANEL
CD	CLEAN OUT
CFM	CUBIC FEET PER MINUTE
CW	COLD WATER
D	DRY BULB TEMPERATURE
DDC	DIRECT DIGITAL CONTROL
dB	DECIBELS
Dp	DEW POINT TEMPERATURE
EA	EXHAUST AIR
EF	EXHAUST FAN
EX	EXISTING
FLR.	FLOOR
FD	FIRE DAMPER
FSD	COMBINATION FIRE/SMOKE DAMPER
GPM	GALLONS PER MINUTE
HC	HEATING COIL
MAX.	MAXIMUM
MIN.	MINIMUM
N.T.S.	NOT TO SCALE
NOM.	NOMINAL
OA	OUTDOOR AIR
PD	PRESSURE DROP
RA	RETURN AIR
RH	REHEAT COIL
Rh	RELATIVE HUMIDITY
SA	SUPPLY AIR
Sp. Gr.	SPECIFIC GRAVITY
SP	STATIC PRESSURE
SPS	STATIC PRESSURE SENSOR
SS	STAINLESS STEEL
TOP	TEMPERATURE CONTROL PANEL
VD	VOLUME DAMPER
VFD	VARIABLE FREQUENCY DRIVE
Wb	WET BULB TEMPERATURE
X	EXISTING
XR	EXISTING TO BE REMOVED
XRL	EXISTING TO BE RELOCATED

### GENERAL SYMBOLS:

	POINT OF CONNECTION BETWEEN NEW AND EXISTING WORK
	LIMIT OF DEMOLITION
	EXISTING TO REMAIN
	EXISTING TO BE REMOVED
	EXISTING TO BE RELOCATED

### CALL OUTS:

	REFERENCE TO CODED NOTE
	EQUIPMENT OR FIXTURE MARK
	UNIT NUMBER
	AIR DISTRIBUTION DEVICE
	CONNECTION SIZE AT DEVICE

### DUCTWORK SYMBOLS:

	24x18 RECTANGULAR DUCT SIZE
	12"ø ROUND DUCT SIZE
	MANUAL BALANCING DAMPER ON DUCT TO BE MOUNTED OVER ACCESSIBLE CEILING
	SUPPLY AIR DUCT
	RETURN AIR DUCT
	EXHAUST AIR DUCT
	SINGLE LINE
	INDICATES TRANSITION
	SUPPLY AIR DIFFUSER
	RETURN AIR GRILLE
	EXHAUST AIR GRILLE
	SHADING INDICATES TO PROVIDE QUADRANT BLANK-OFF IN NECK OF DIFFUSER. TO BE FURNISHED WITH DIFFUSER.
	SUPPLY DUCT (UP & DOWN)
	EXHAUST DUCT (UP & DOWN)
	SUPPLY TOP REGISTER OR GRILLE (WALL TYPE)
	EXHAUST OR RETURN CEILING REGISTER OR GRILLE
	EXHAUST OR RETURN BOTTOM REGISTER OR GRILLE (WALL TYPE)
	EXHAUST OR RETURN REGISTER OR TOP GRILLE (WALL TYPE)
	CONNECT NEW DUCT TO EXISTING DUCT
	LIMIT OF DEMOLITION
	FIRE DAMPER

### CONTROL SYMBOLS:

	PNEUMATIC THERMOSTAT
	DDC THERMOSTAT

### HVAC PIPING:

	9'-2" HEIGHT OF BOTTOM OF PIPE ABOVE FLOOR
	CONDENSATE PIPING
	HEATING HOT WATER SUPPLY
	HEATING HOT WATER RETURN
	DRAIN
	VENT LINE
	SHUTOFF VALVE
	SHUTOFF VALVE IN VERTICAL PIPE
	CHECK VALVE
	UNION
	REDUCER OR INCREASER
	PIPE TRANSITION
	ECCENTRIC REDUCER
	TOP CONNECTION, 45° OR 90°
	BOTTOM CONNECTION, 45° OR 90°
	SIDE CONNECTION
	DIRECTION OF FLOW
	STRAINER
	BALANCING VALVE
	FLEXIBLE PIPE CONNECTOR
	GAUGE PORT (PETE'S PLUG)
	2-WAY CONTROL VALVE
	PRESSURE GAUGE
	LOCAL DRAIN, VALVED WITH 3/4" THREADED CONNECTOR
	NORMALLY OPEN
	NORMALLY CLOSED
	MANUAL AIR VENT

## HVAC GENERAL NOTES:

- LOCATIONS AND ROUTING OF EXISTING PIPING, DUCTWORK AND EQUIPMENT IS PRESUMED FROM EXISTING DRAWINGS. MECHANICAL CONTRACTOR SHALL FIELD VERIFY ALL PRIOR TO COMMENCEMENT OF CONSTRUCTION. NOTIFY ENGINEER OF ANY CONDITIONS WHICH WILL NOT PERMIT THE WORK TO BE PERFORMED AS INDICATED ON THESE DRAWINGS.
- COORDINATE ALL SHUT-DOWNS OF EXISTING MECHANICAL SYSTEMS WITH OWNER A MINIMUM OF TEN WORKING DAYS IN ADVANCE.
- PRIOR TO INSTALLATION, VERIFY PRECISE LOCATION OF NEW WALL MOUNTED DEVICES WITH OWNER AND ARCHITECT. REFER TO ARCHITECTURAL REFLECTED CEILING PLAN FOR PRECISE LOCATION OF CEILING MOUNTED DEVICES. COORDINATE ROOF MOUNTED EQUIPMENT WITH ARCHITECT PRIOR TO INSTALLATION.
- PROVIDE ADEQUATE SERVICE CLEARANCE FOR ALL MECHANICAL EQUIPMENT. REFER TO INSTRUCTIONS FROM THE EQUIPMENT MANUFACTURER. MAINTAIN A MINIMUM OF 18 INCH CLEARANCE AT CONTROLS FOR VARIABLE AIR VOLUME TERMINALS AND VENTURI VAV TERMINALS.
- NEW DUCTS OR PIPING SHALL NOT BE ROUTED ABOVE ELECTRICAL PANELS. REFER TO ELECTRICAL DRAWINGS FOR LOCATION OF PANELS.
- UNLESS NOTED OTHERWISE, BRANCH DUCTS TO DIFFUSERS SHALL BE THE SAME SIZE AS THE NECK OF THE DIFFUSER.
- NO TEMPERATURE SENSING CONTROL DEVICES SHALL BE LOCATED OVER HEAT PRODUCING DEVICES.
- MECHANICAL DRAWINGS ARE DIAGRAMMATIC. WHERE DUCT SIZE SHOWN IS IN CONFLICT WITH STRUCTURE OR OTHER BUILDING SYSTEM, CONTRACTOR MAY MODIFY DUCT SIZE AND PROVIDE EQUIVALENT FREE AREA DUCT.
- WHERE EQUIPMENT IS TO BE REMOVED, REMOVE ALL ASSOCIATED PIPING, DUCTWORK, CONTROLS, CONCRETE PADS, SUPPORTS, ETC. PATCH WALL AND FLOOR OPENINGS TO MATCH ADJACENT SURFACES.
- CONTRACTOR SHALL REMOVE AND REPLACE CEILING TILES AND GRID AS REQUIRED TO COMPLETE DEMOLITION AND NEW WORK IN AREAS OUTSIDE OF RENOVATION PROJECT. CONTRACTOR SHALL BE RESPONSIBLE FOR REPLACING ANY TILES OR GRID DAMAGED DUE TO THIS WORK.

## HVAC DESIGN DATA

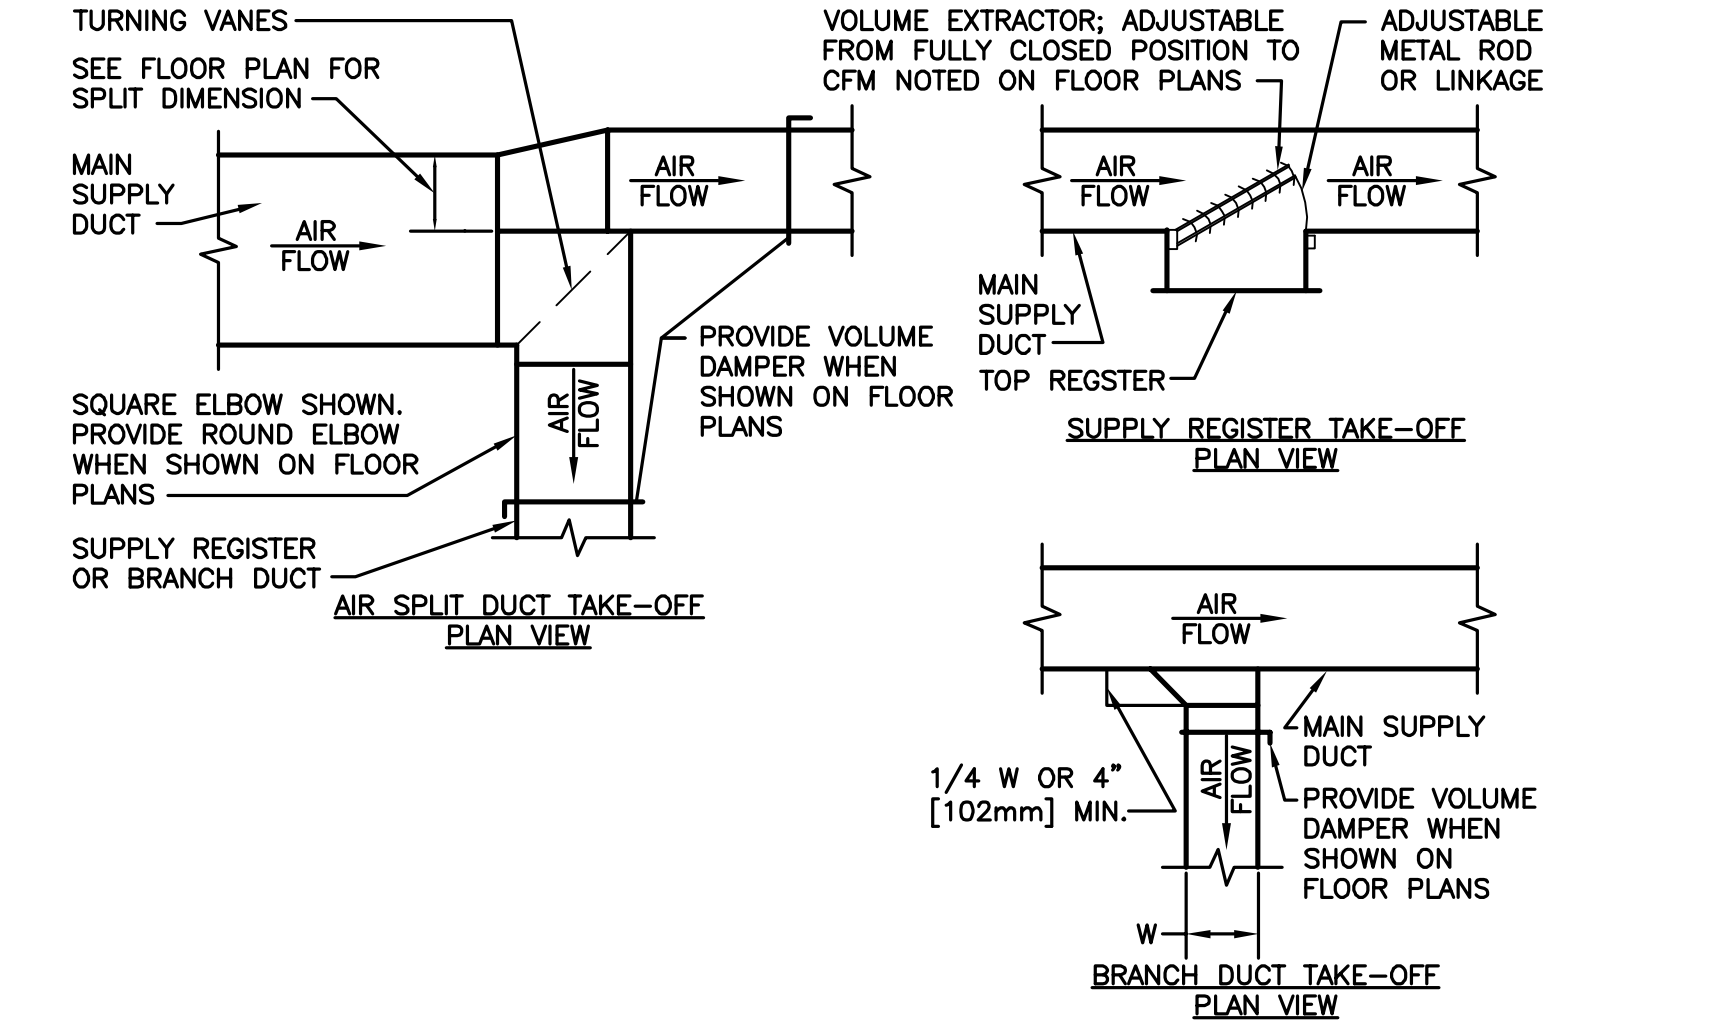
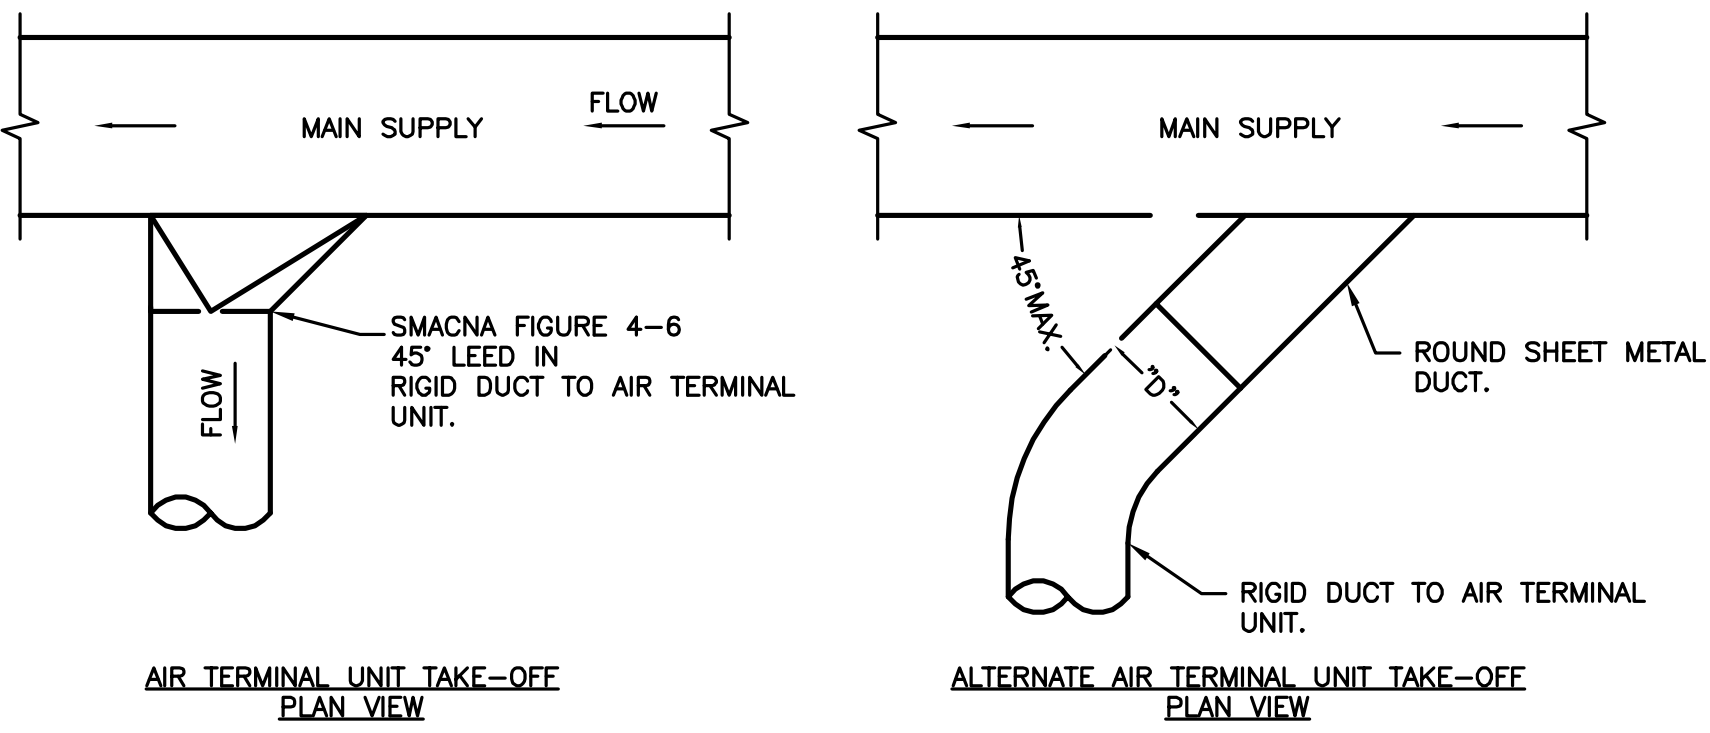
OUTDOOR DESIGN TEMPERATURES	89.4°F Db SUMMER 73.9°F Wb SUMMER -4.0°F Db WINTER		DESIGN ALTITUDE: 800 FT.	
	SUMMER		WINTER	
INDOOR AREA DESIGN CONDITIONS	Db °F	RELATIVE HUMIDITY (%)	Db °F	RELATIVE HUMIDITY (%)
CORRIDIOR	75	60	70	20
OFFICES	75	60	70	20
WAITING/PUBLIC AREAS	75	60	70	20

## FULLY SPRINKLERED


<b>CONSULTANTS:</b>   <b>FREDRICK, FREDRICK &amp; HELLER ENGINEERS, INC.</b> 672 EAST ROYALTON ROAD BROADVIEW HTS., OHIO 44147 TEL. (440) 546-9696 FAX. (440) 546-9696				<b>ARCHITECT:</b>   <b>Perspectus architecture</b> 13212 Shaker Square Suite 204 Cleveland, Ohio 44120 P. 216.752.1800 F. 216.752.3833		Drawing Title <b>HVAC LEGEND AND SCHEDULES</b>  Approved: Project Director		Project Title <b>SOCIAL WORK AND HBPC OFFICE RENOVATION</b>  Location <b>VAMC - WADE PARK</b>		Project Number 541-12-104  Building Number 1  Drawing Number <b>1-H1</b> Dwg. of		<b>Office of Facilities Management</b>  	
Final Bid Set Documents Revisions:		4-27-12 Date											




three inches = one foot  
one and one half inches = one foot  
one inch = one foot  
one quarter inch = one foot  
one half inch = one foot  
three eighths inch = one foot  
one eighth inch = one foot  
one quarter inch = one foot  
one eighth inch = one foot




DUCTWORK TAKE-OFFS  
NTS

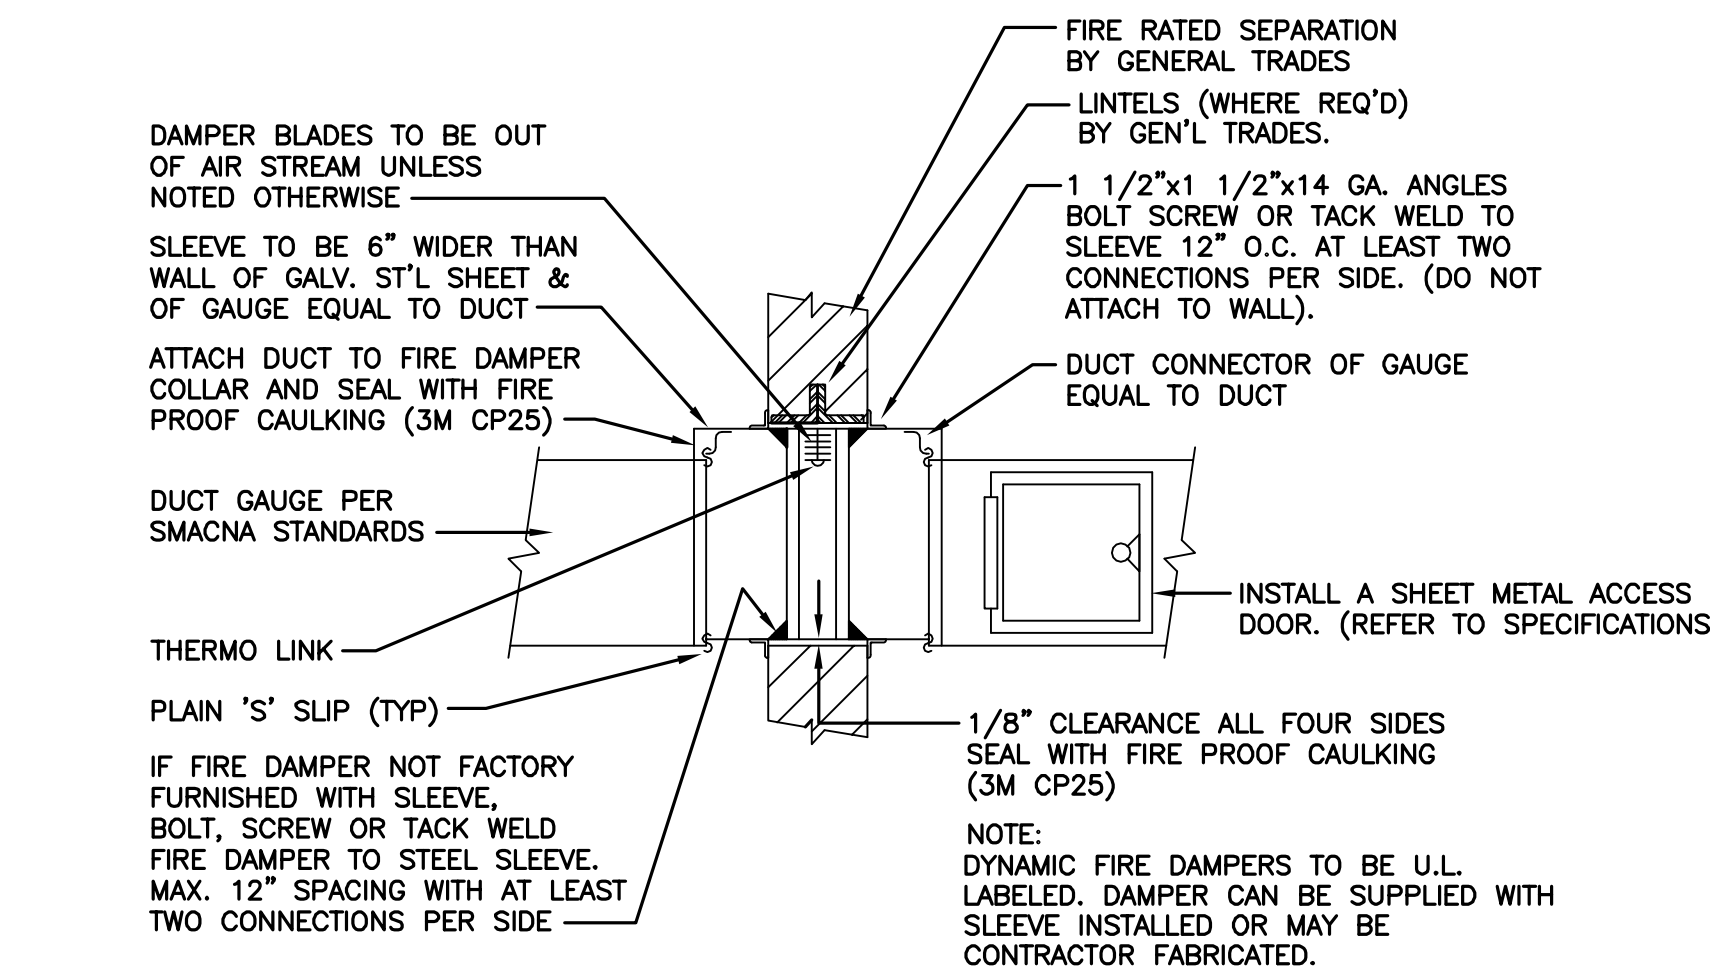

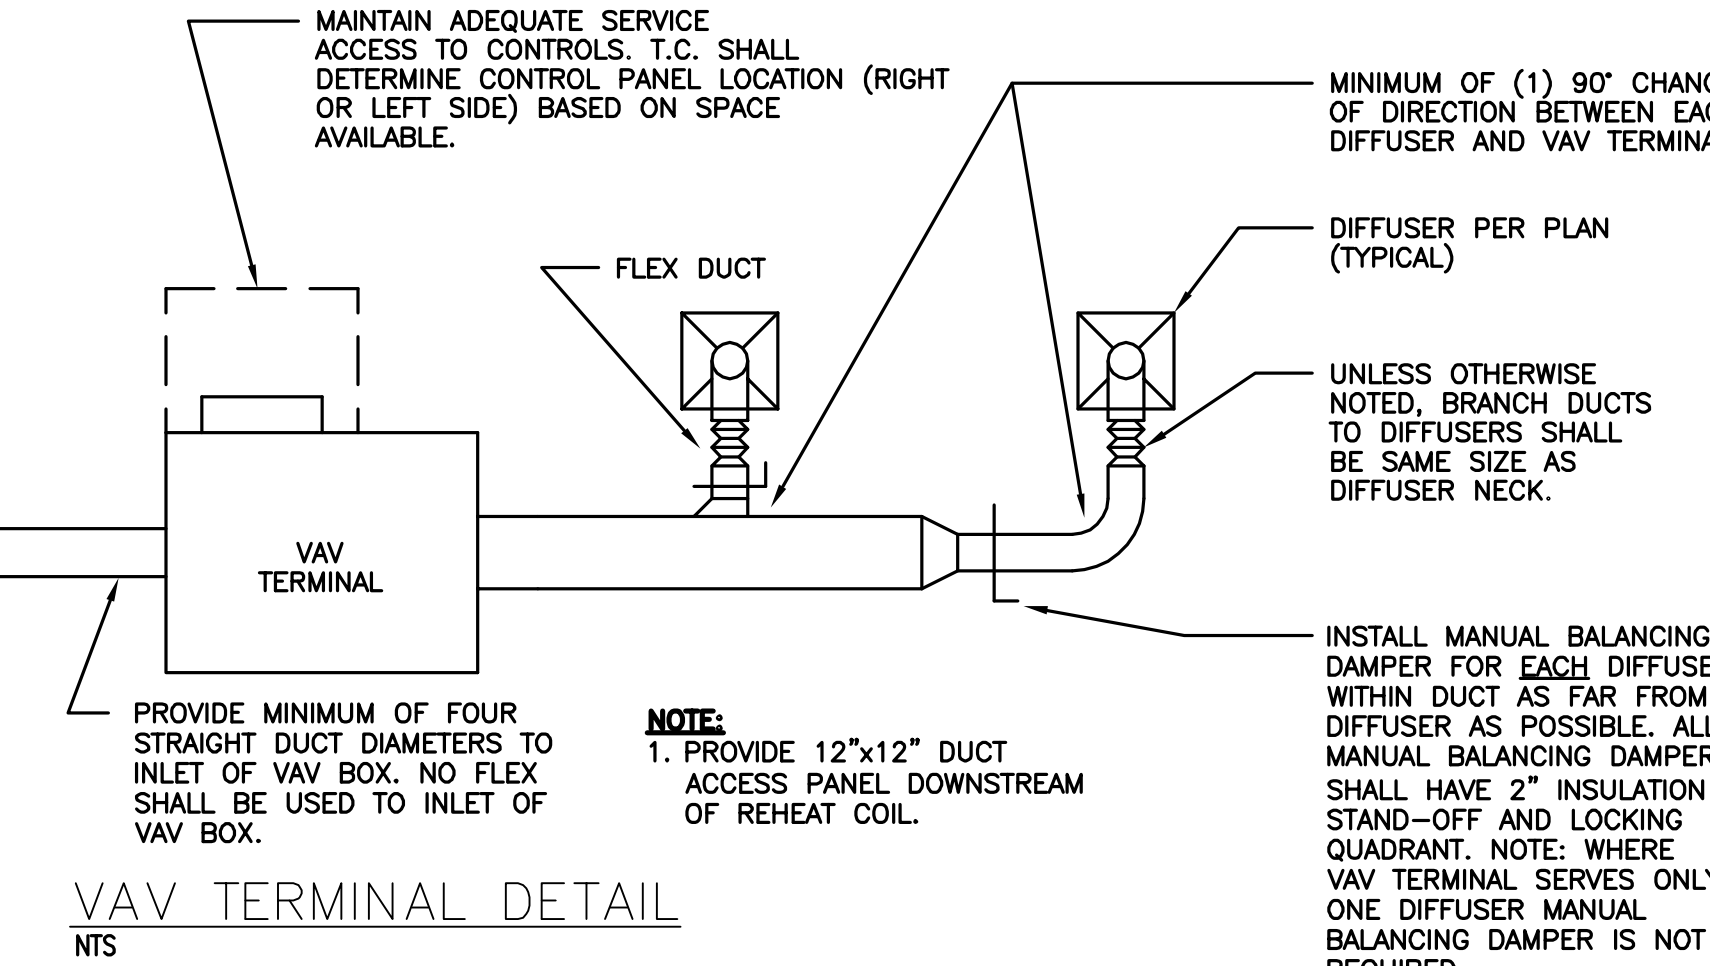TYPICAL FIRE DAMPER AT WALL PENETRATION DETAIL  
NTS




VAV TERMINAL DETAIL  
NTS

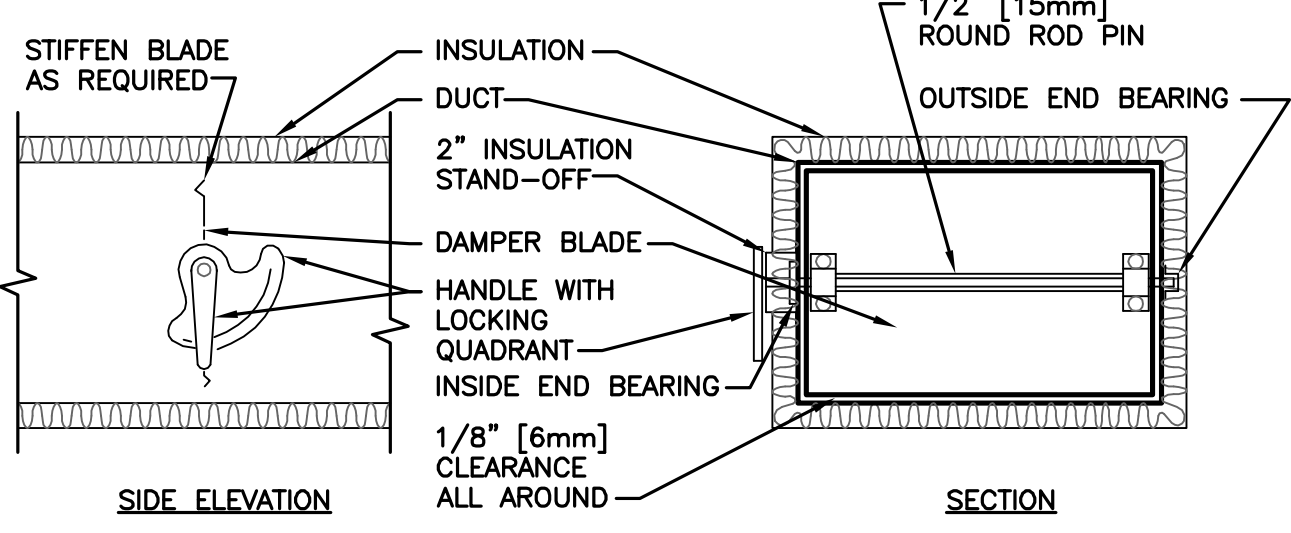


- NOTE:
1. DELETE INSULATION STAND-OFF ON DUCTWORK WITHOUT EXTERIOR INSULATION.
  2. DETAIL SHOWS SINGLE BLADE DAMPER. DAMPER INSTALLATION SHALL BE SIMILAR FOR MULTI-BLADE DAMPERS & ROUND DAMPERS.

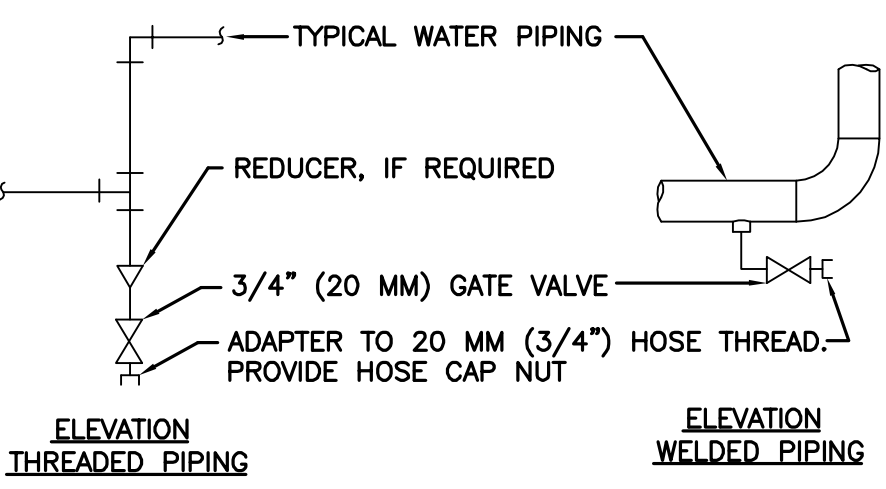VOLUME DAMPER DETAIL  
NTS




- NOTES:
1. DRAIN ALL LOW POINTS AS INDICATED ABOVE.
  2. WHERE SCALE POCKETS ARE SHOWN ON PIPE RISER DIAGRAMS AND/OR PLANS LOCATE DRAIN AT BOTTOM OF SCALE POCKET.

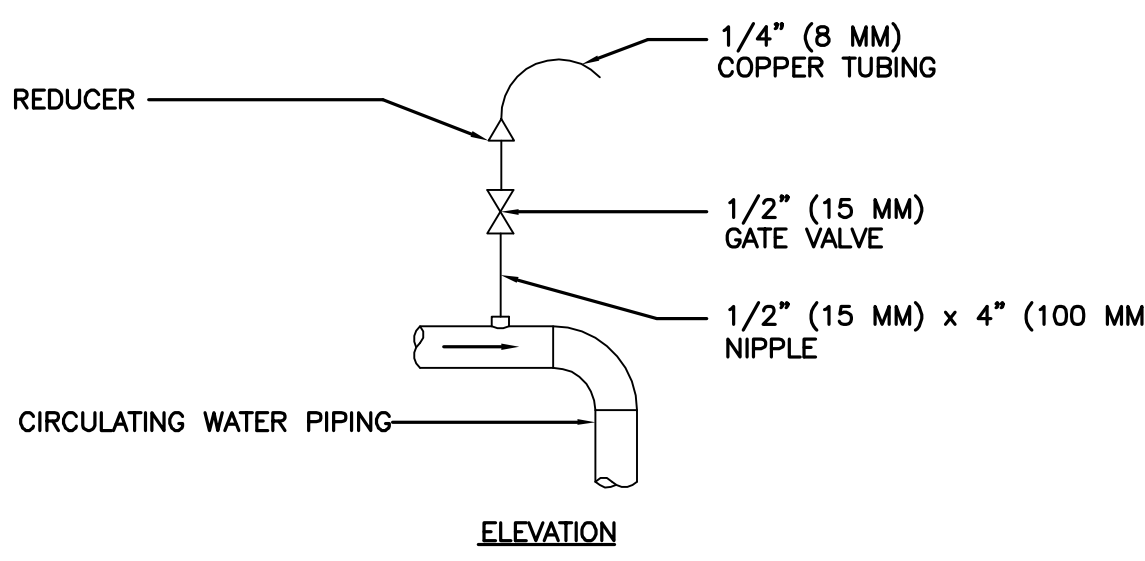TYPICAL CHILLED AND HOT WATER PIPING DRAIN VALVE CONNECTIONS




TYPICAL AIR VENT

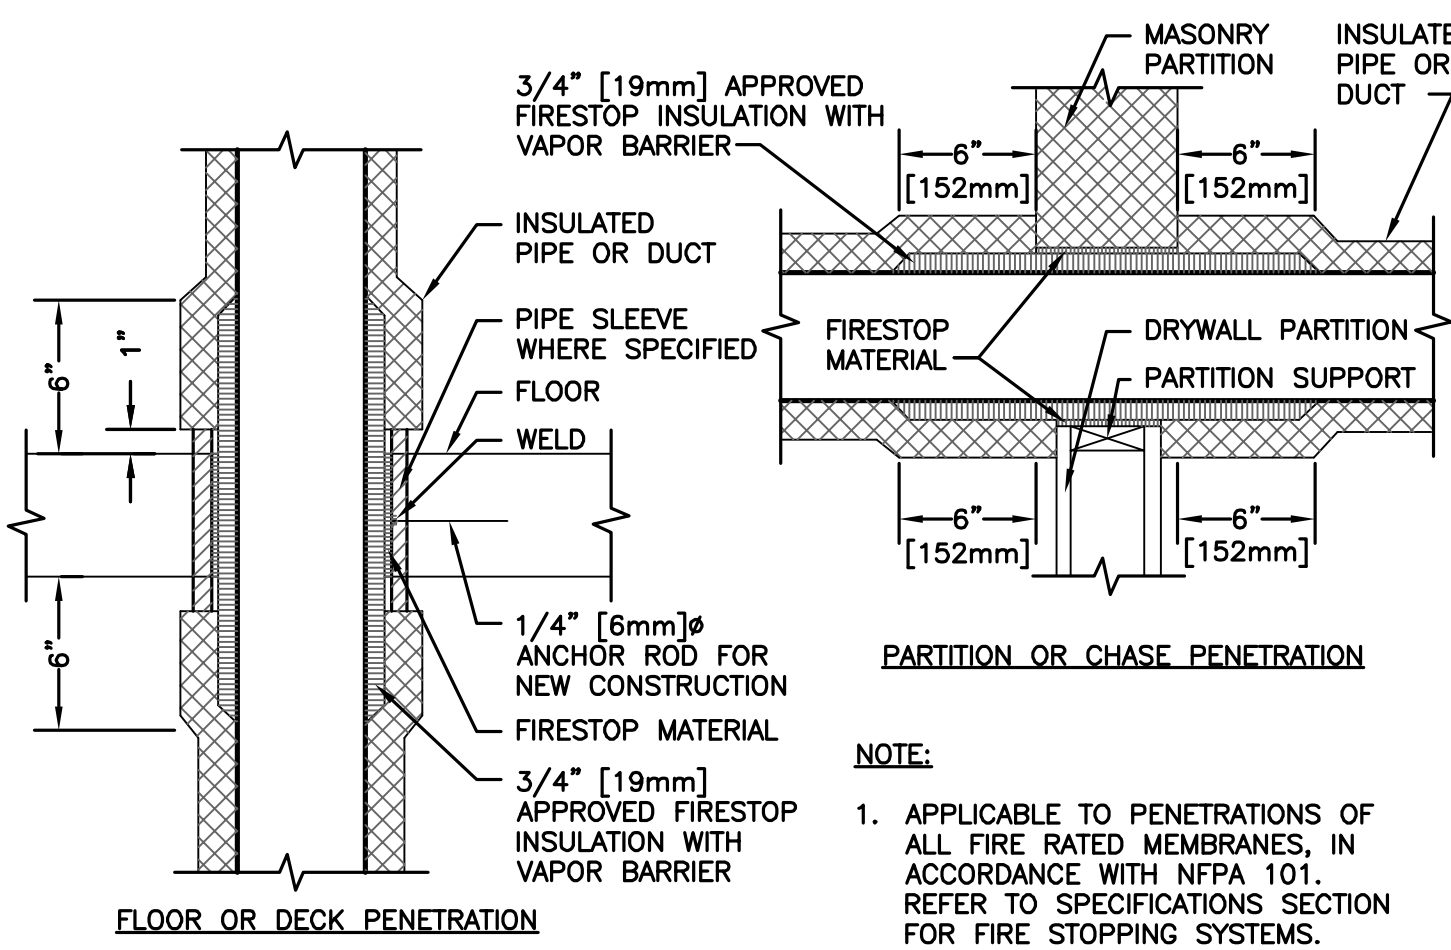- NOTES:
1. VENT ALL HIGH POINTS INDICATED ABOVE.
  2. IF AUTOMATIC AIR VENTS ARE USED, PIPE DISCHARGE TO DRAIN




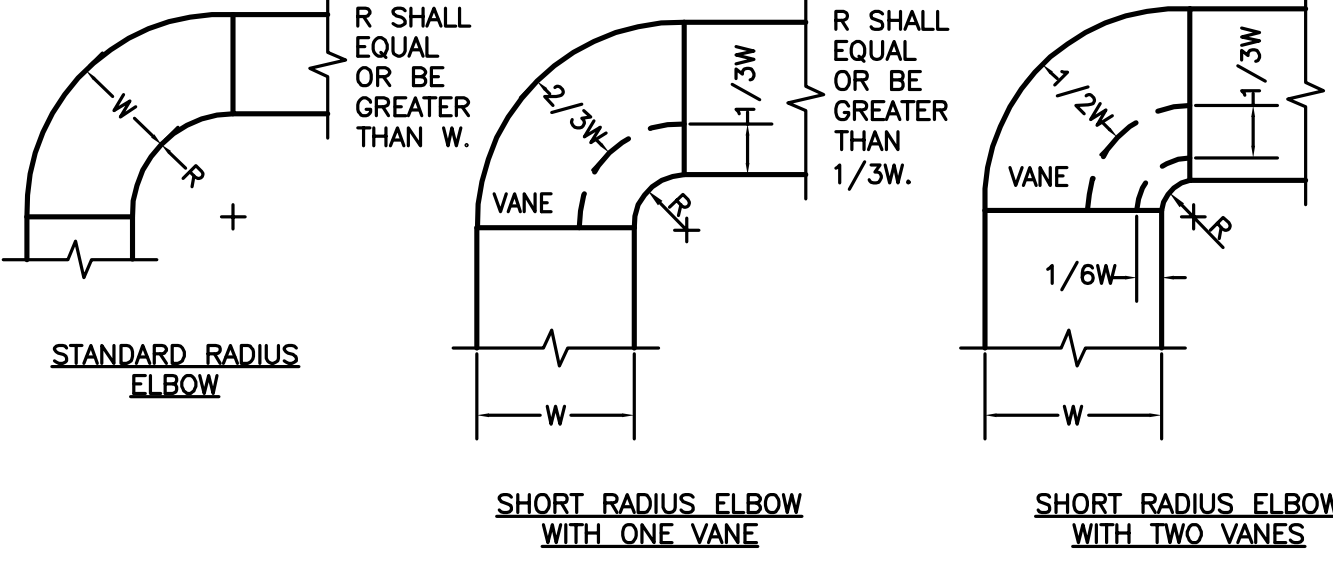PIPE/DUCT PENETRATION OF FIRE/SMOKE BARRIERS  
NTS




- NOTE:
1. THE INTERIOR SURFACE OF ALL RADIUS ELBOWS SHALL BE MADE ROUND.
  2. ALL STANDARD RADIUS ELBOWS SHOWN ON FLOOR PLANS MAY BE MADE SHORT RADIUS ELBOWS. ALL SHORT RADIUS ELBOWS SHALL HAVE VANES. VANES SHALL BE CONSTRUCTED, SUPPORTED AND FASTENED AS RECOMMENDED BY SMACNA.

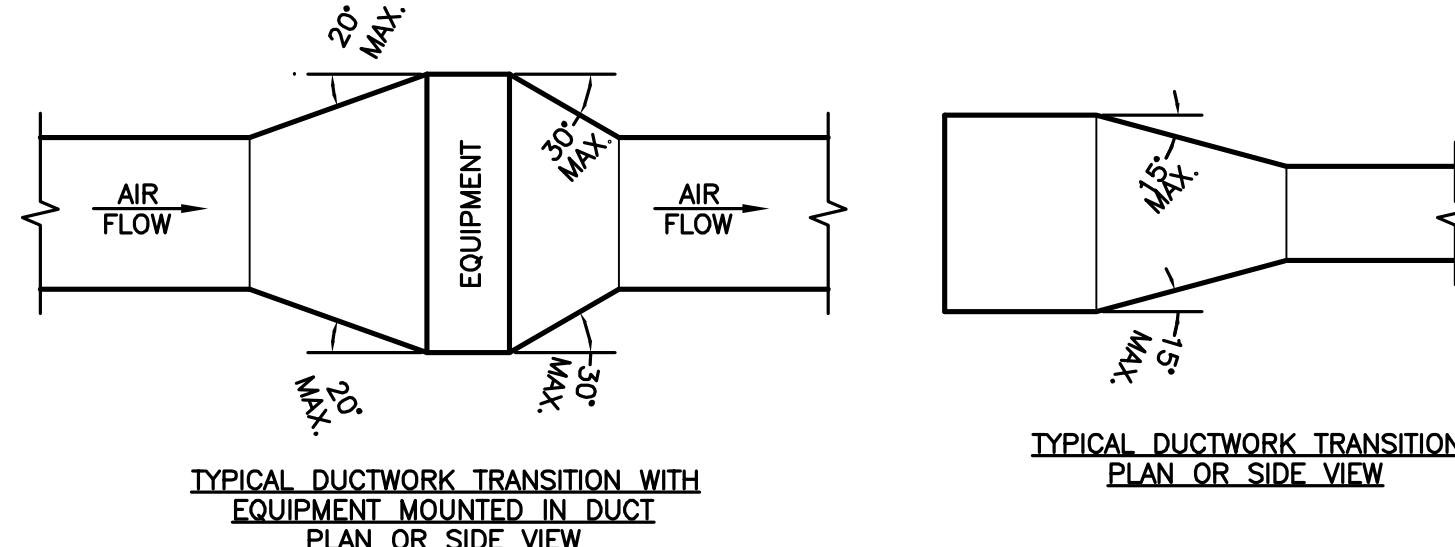DUCTWORK RADIUS ELBOWS  
NTS




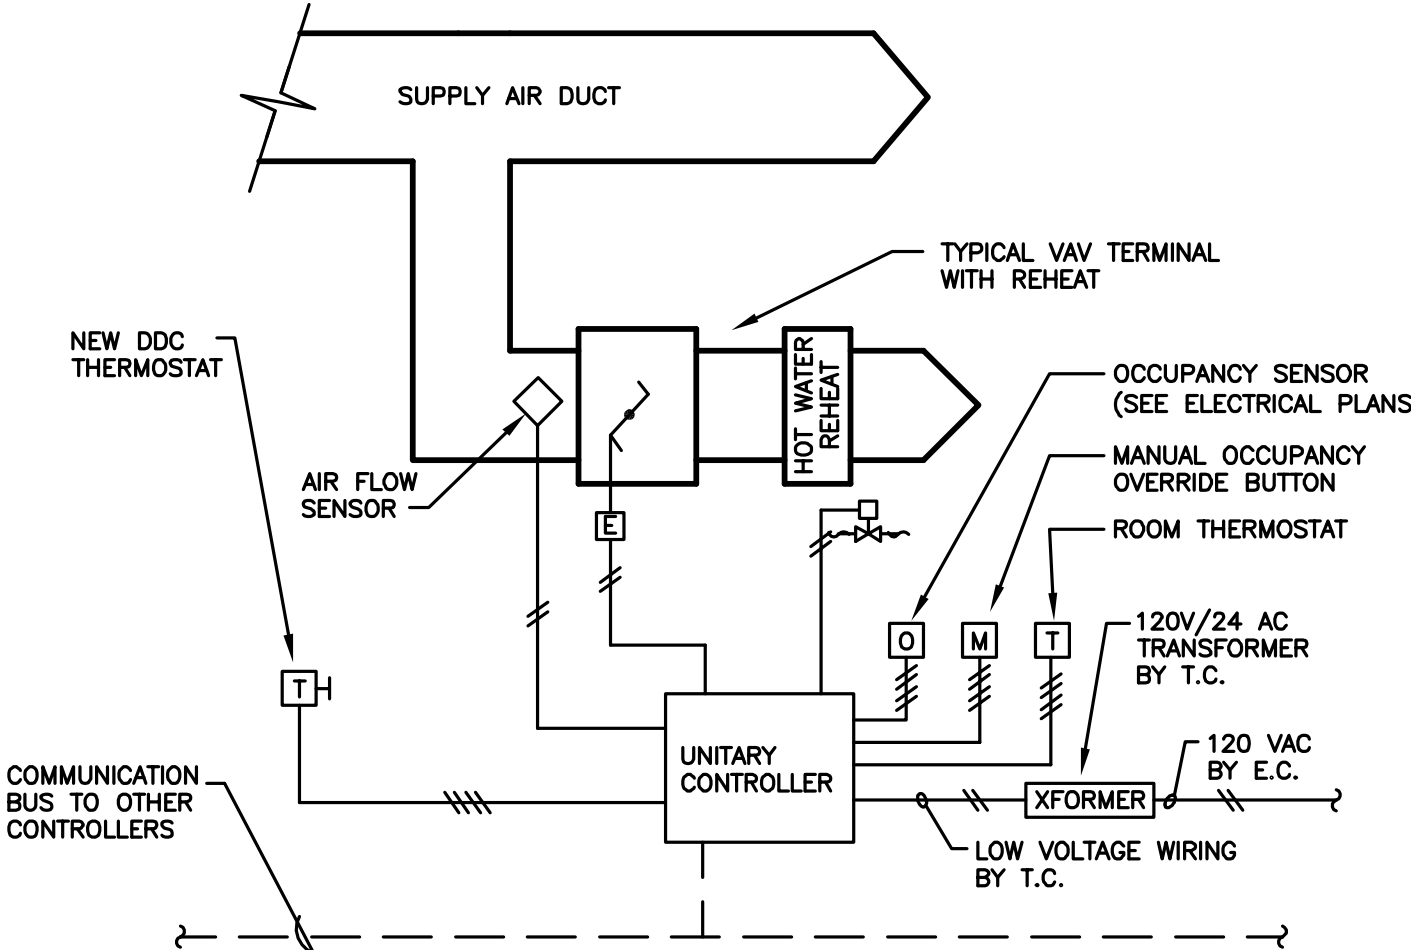TYPICAL DUCTWORK TRANSITION WITH EQUIPMENT MOUNTED IN DUCT  
NTS




SEQUENCE OF OPERATION FOR VAV BOXES

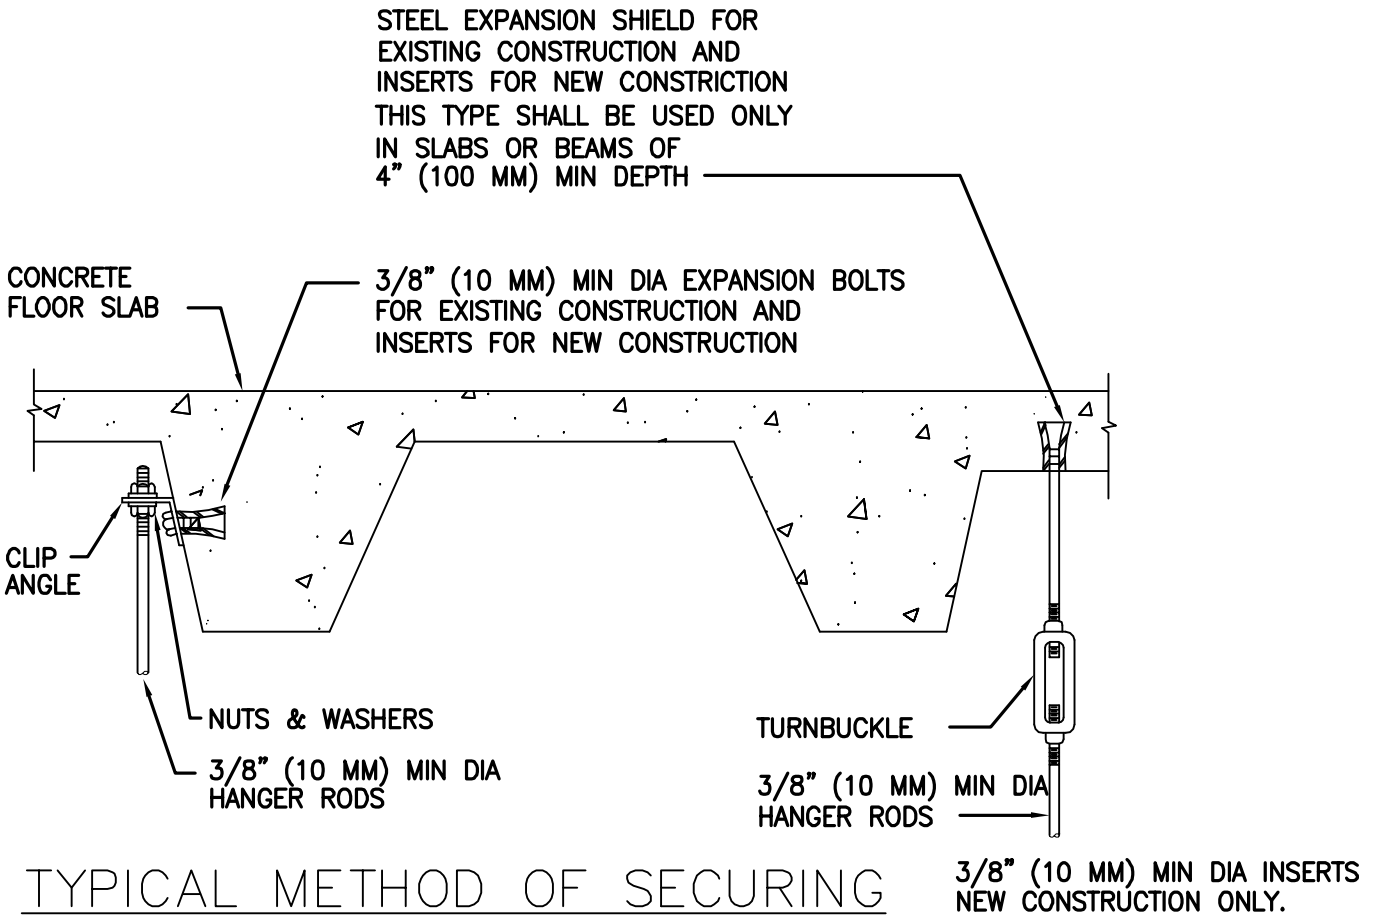
- OPERATION:
- A. SPACE THERMOSTAT SHALL MODULATE DAMPER TO MAINTAIN SET POINT.
  - B. ON CALL FOR HEAT, RETURN DAMPER TO MINIMUM POSITION AND MODULATE HOT WATER VALVE TO MAINTAIN SETPOINT.
- OCCUPANCY CONTROL:
- A. OCCUPANCY SHALL BE DETERMINED FROM ELECTRICAL LIGHTING OCCUPANCY SENSOR SYSTEM FOR RESPECTIVE SERVICE AREA. CONTRACTOR SHALL TIE INTO ELECTRICAL OCCUPANCY SENSOR VIA AUXILIARY DRY CONTACTS ON SENSORS. REFER TO ELECTRICAL PLANS FOR ADDITIONAL INFORMATION.
  - B. ROOM OVERRIDE SHALL BE POSSIBLE FROM MANUAL OCCUPANCY BUTTON. OVERRIDE SHALL BE LIMITED TO 60 MINUTES (ADJ.)
  - C. OCCUPIED: VAV TERMINAL SHALL OPERATE UNDER STANDARD COOLING/HEATING MODES TO MAINTAIN ROOM THERMOSTAT SETPOINTS AS LISTED IN ROOM DESIGN SCHEDULE ON DRAWING 1-H1.
  - D. UNOCCUPIED:
    1. VAV TERMINAL SHALL RESET TO UNOCCUPIED MINIMUM. UNOCCUPIED MINIMUM SHALL BE 50% OF OCCUPIED MINIMUM (OCCUPIED MINIMUM IS LISTED MINIMUM AIR FLOW IN VAV SCHEDULE).
    2. VAV TERMINAL SHALL OPERATE COOLING/HEATING MODES TO MAINTAIN 'UNOCCUPIED' SPACE THERMOSTAT SETPOINTS:
    3. UNOCCUPIED SPACE THERMOSTAT SETPOINTS:
      - a. HEATING: 68° F
      - b. COOLING: 78° F
- NOTES:
- A. DAMPER OPERATORS TO BE PROVIDED BY TEMPERATURE CONTROLS CONTRACTOR.
  - B. TEMPERATURE CONTROL TEST SHALL INCLUDE, BUT NOT BE LIMITED TO:
    - DAMPER OPERATION
    - VALVE ACTUATION RESPONSE AND VALIDATION OF CORRECT OPERATION
    - VERIFIED ENTIRE CONTROL SEQUENCE OPERATES PER DESIGN
    - ACCOUNT FOR ALL CONTROL POINTS LISTED
  - C. ALL SYSTEMS SHALL BE COMMISSIONED. REFER TO SPECIFICATIONS FOR ADDITIONAL INFORMATION.
  - D. TEMPERATURE CONTROLS SHALL BE ANDOVER. ALL CONTROLS WORK SHALL INTERFACE WITH EXISTING ANDOVER BUILDING CONTROL SYSTEM.



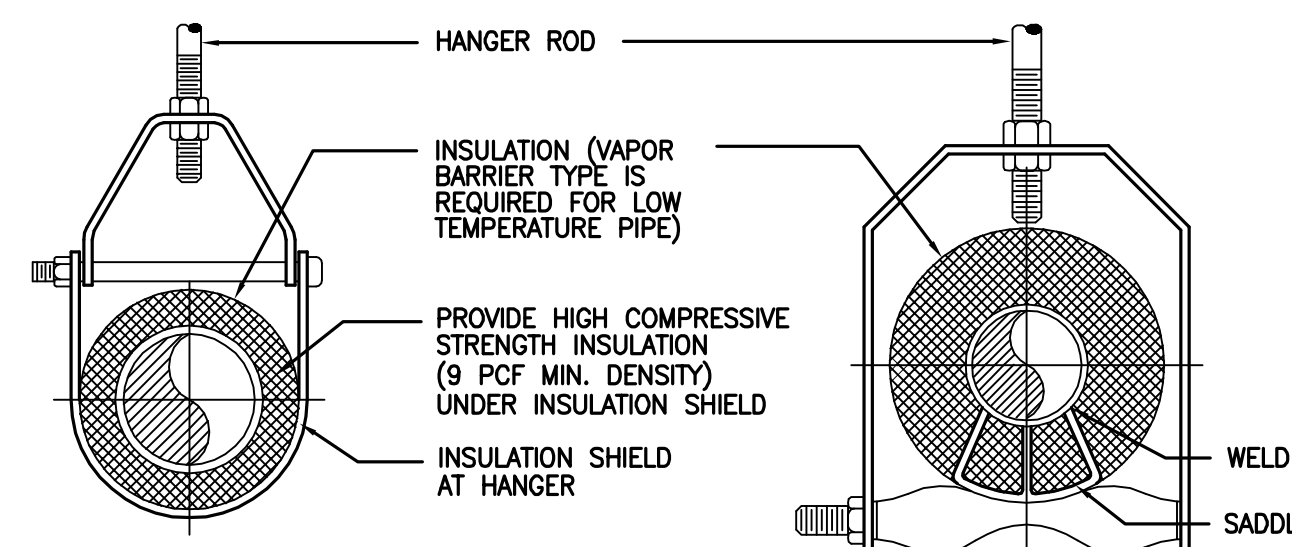TYPICAL METHOD OF SECURING HANGER RODS IN CONCRETE SLABS AND BEAMS.  
NTS



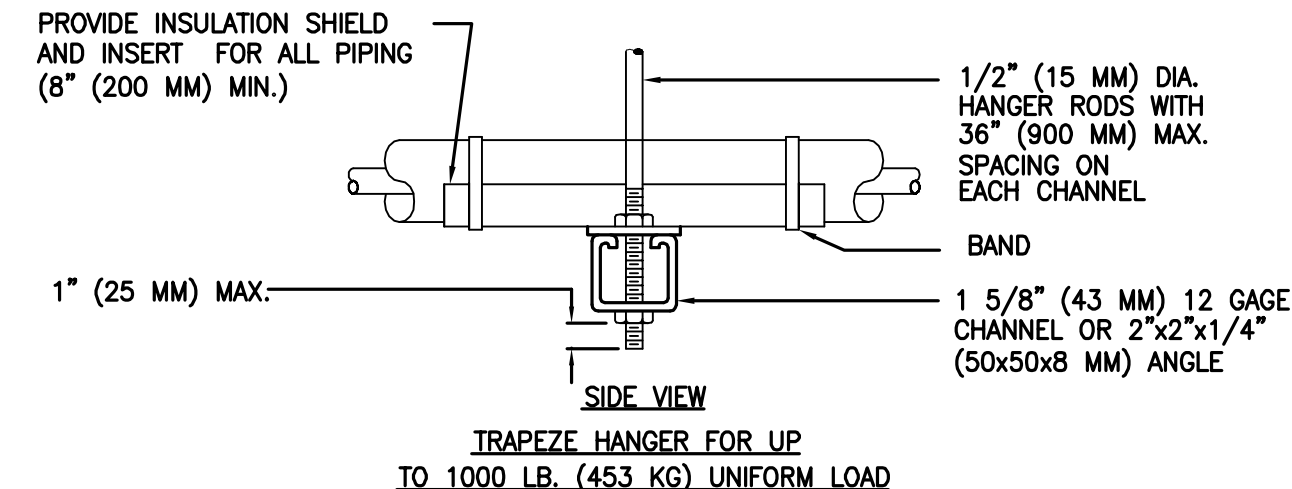
ADJUSTABLE CLEVIS HANGER TYPE 1 - SEE SPECIFICATIONS



TYPICAL PIPE HANGERS  
NTS

		MAXIMUM PIPE/TUBING SUPPORT SPACING															
NOM. SIZE IN. (MM)	THRU (20)	3/4 (25)	1 (32)	1 1/8 (40)	1 1/2 (50)	2 (51)	2 1/2 (64)	3 (76)	4 (102)	5 (127)	6 (152)	8 (203)	10 (254)	12 (305)	14 (356)	16 (406)	18 (457)
PIPE	(2.1)	(2.1)	(2.1)	(2.7)	(3.0)	(3.4)	(3.7)	(4.1)	(4.9)	(5.2)	(5.8)						
TUBING	5 FT (1.5)	6 (1.8)	7 (2.1)	8 (2.4)	9 (2.7)	10 (3.0)	12 (3.7)	14 (4.0)	16 (4.9)	18 (5.2)	20 (5.8)	24 (6.1)	30 (7.6)	36 (9.1)	42 (10.7)	48 (12.2)	60 (15.2)

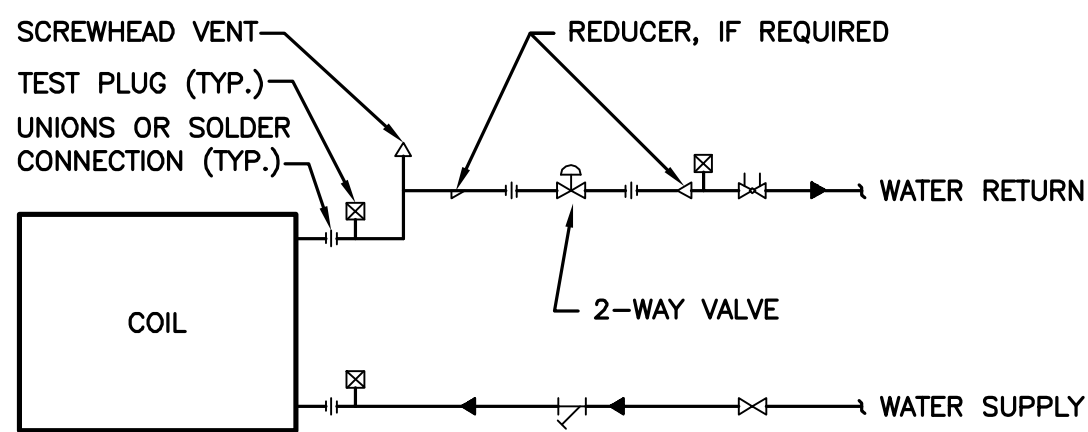NOTE: FOR TRAPEZE HANGER TAKE SPACING OF SMALLEST SIZE ON TRAPEZE.




TYPICAL COIL PIPING CONNECTIONS VAV AND DUCT-MOUNTED REHEAT COILS  
NTS

- NOTES:
1. BRANCH PIPING VALVES SHALL BE PROVIDED WITH PACKING GLANDS.

Final Bid Set Documents	4-27-12
Revisions:	Date

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Perspectus  
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Drawing Title  
HVAC DETAILS

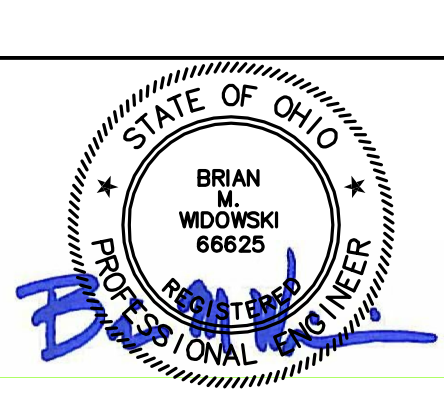Approved: Project Director

Project Title  
SOCIAL WORK AND HBPC OFFICE RENOVATION

Location  
VAMC - WADE PARK

Date  
04-27-12

Checked  
LDH

Drawn  
SEP

Project Number  
541-12-104

Building Number  
1

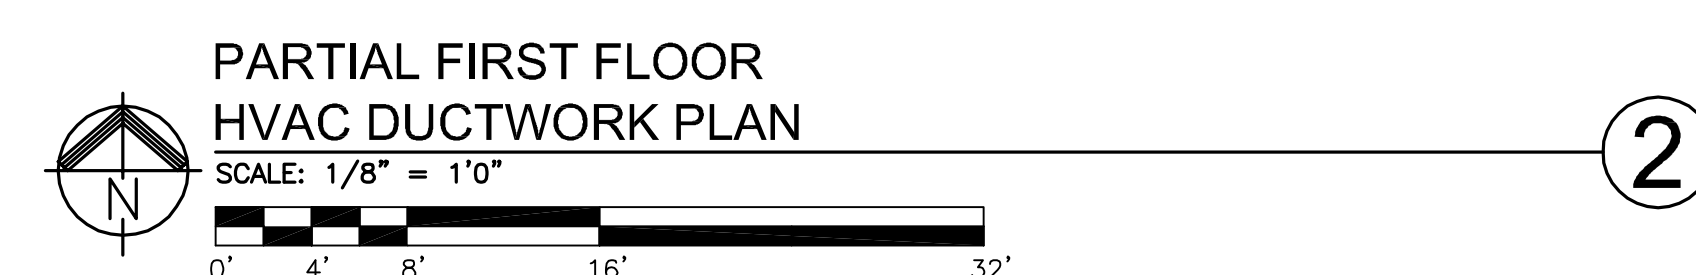
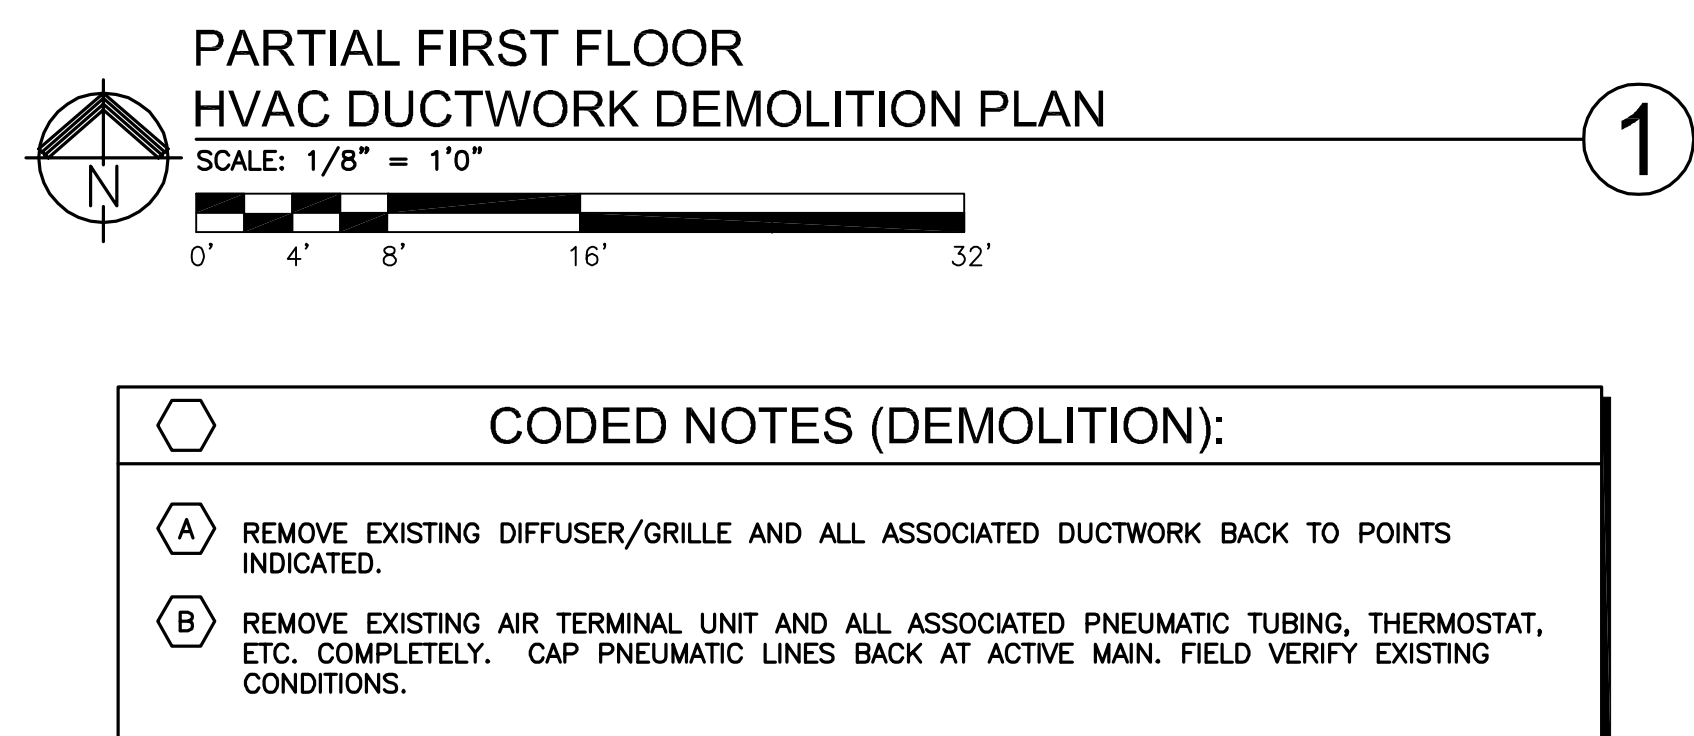
Drawing Number  
1-H2

Dwg. of


Office of Facilities Management






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PARTIAL FIRST FLOOR HVAC  
PIPING DEMOLITION PLAN  
SCALE: 1/8" = 10'

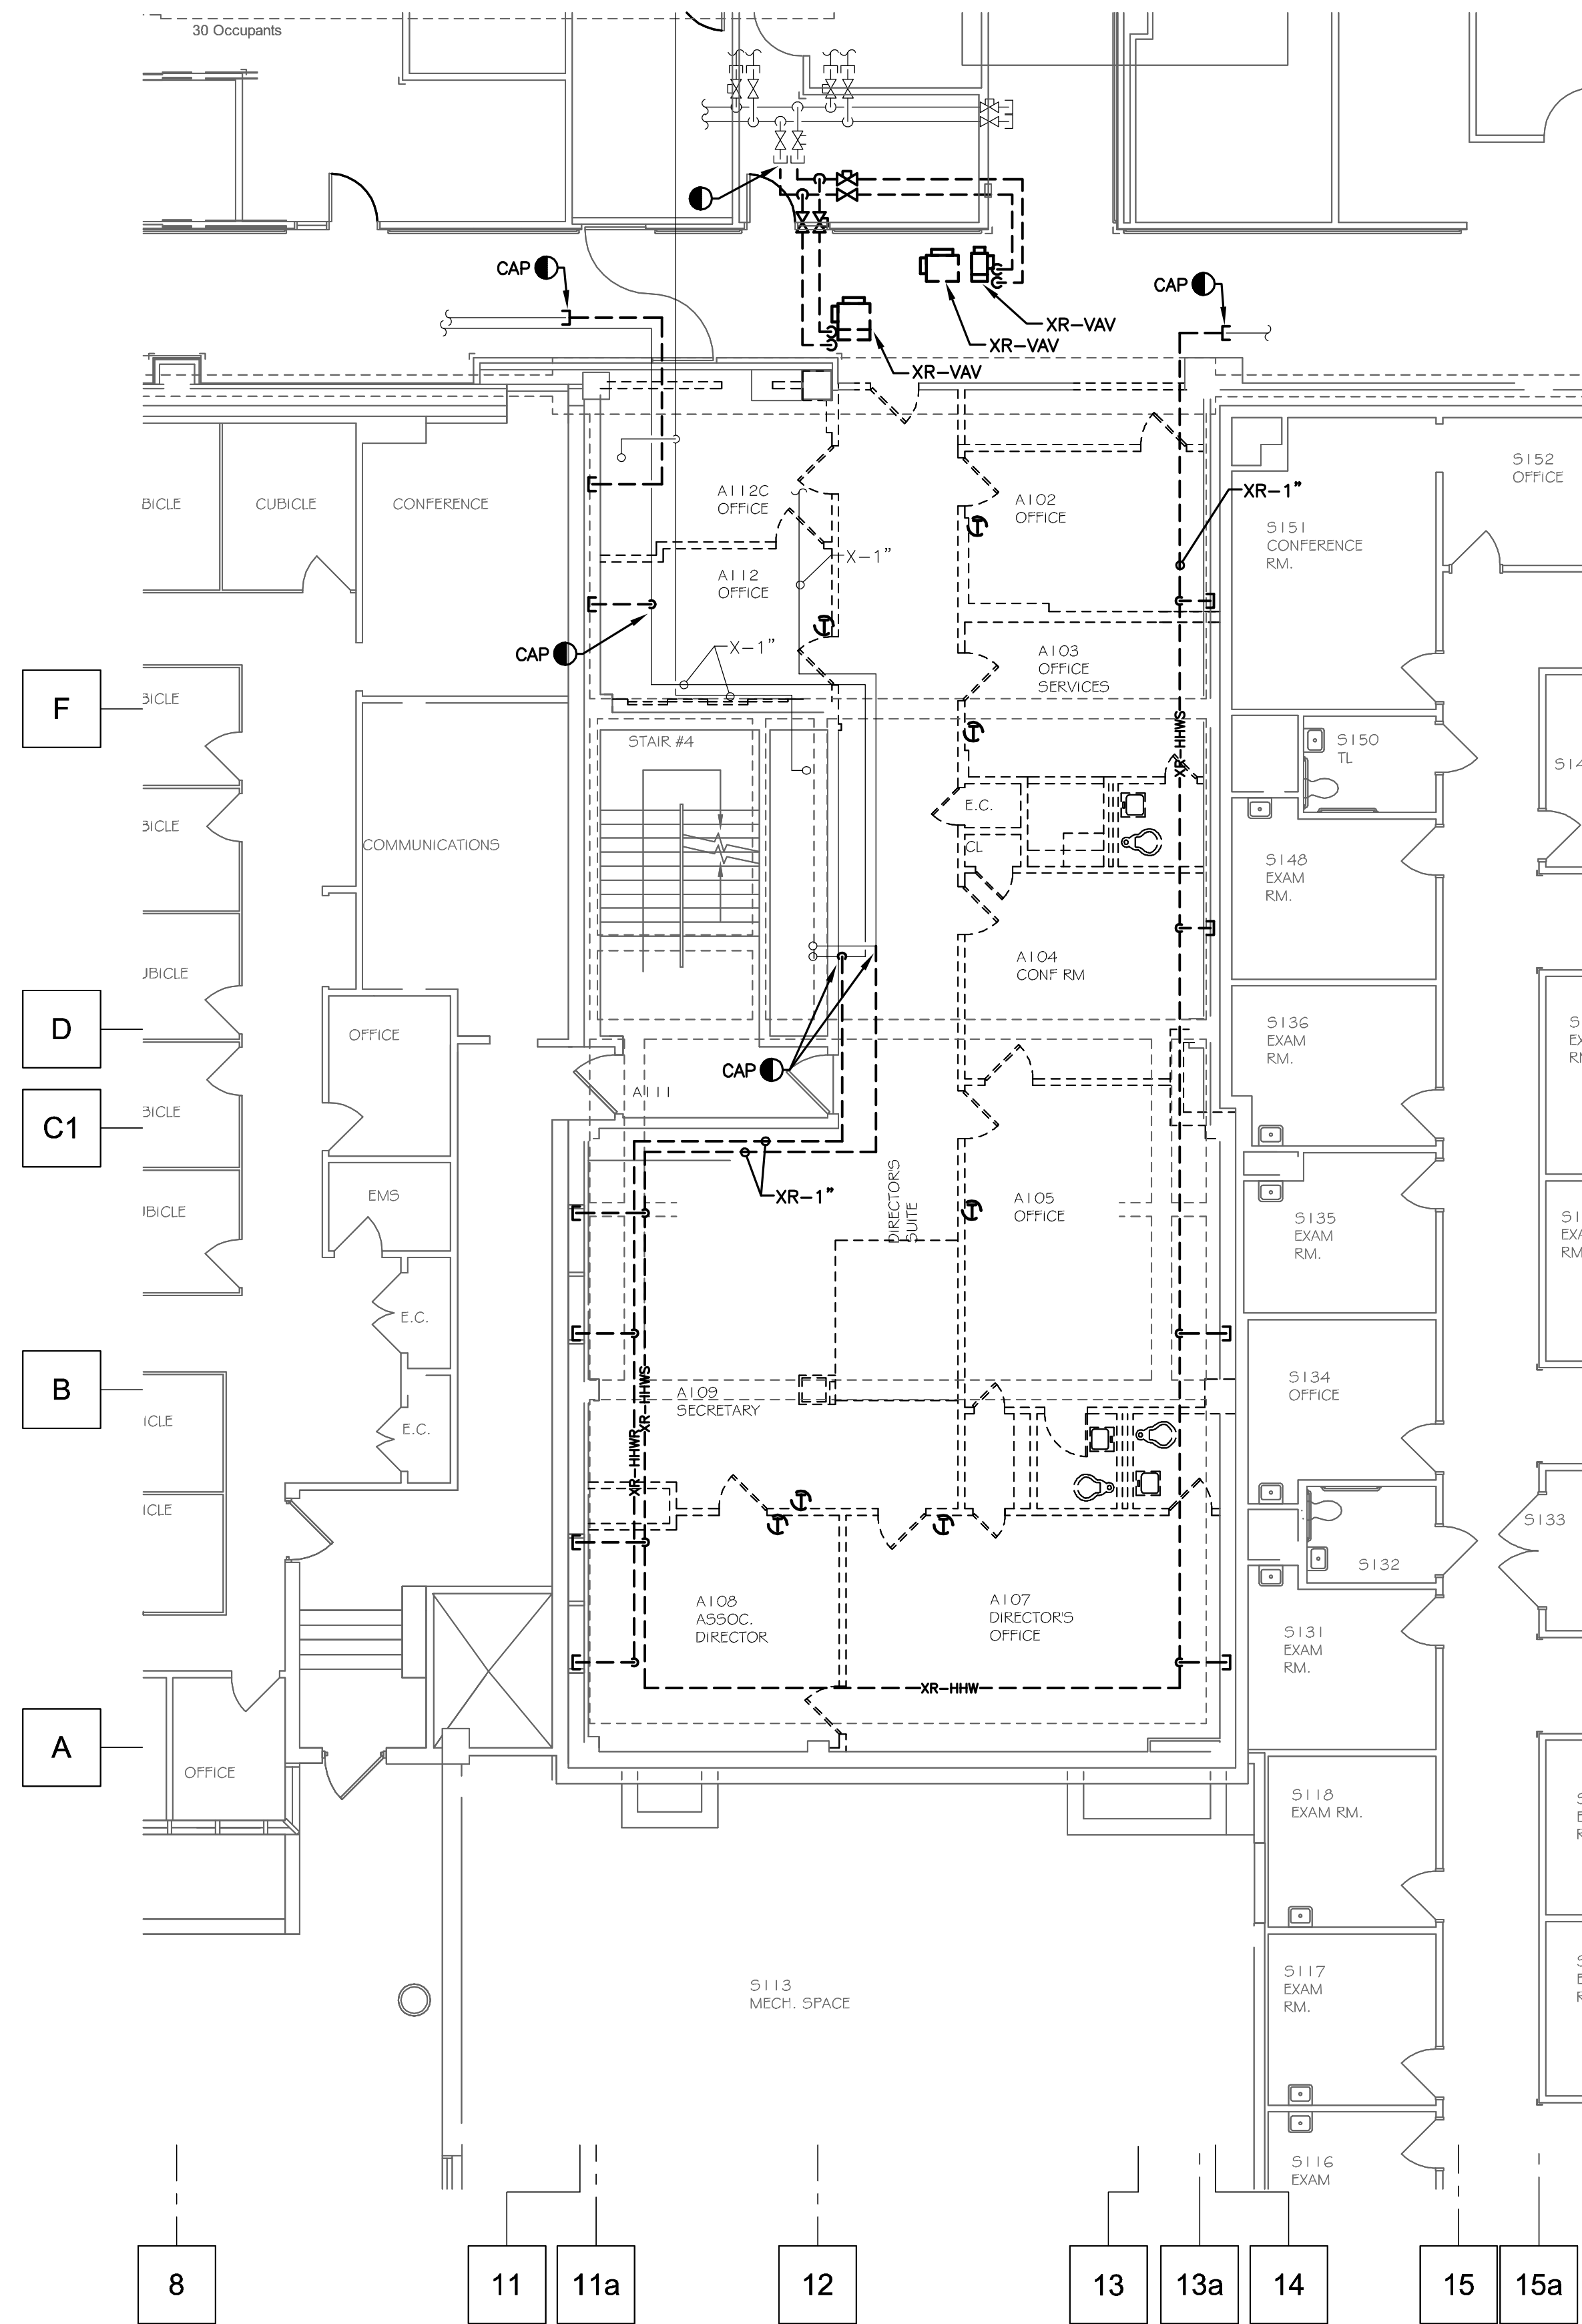GENERAL NOTES (DEMOLITION):  
A. PLAN SHOWS ANTICIPATED AMOUNT OF PERIMETER HEATING PIPING TO BE REMOVED. CONTRACTOR SHALL FIELD VERIFY ALL EXISTING PERIMETER HEATING HOT WATER PIPING WITHIN PROJECT SCOPE AREA. IF PIPING IS VERIFIED ABANDONED OR NOT BEING UTILIZED WITHIN PROJECT SPACE, IT SHALL BE REMOVED.



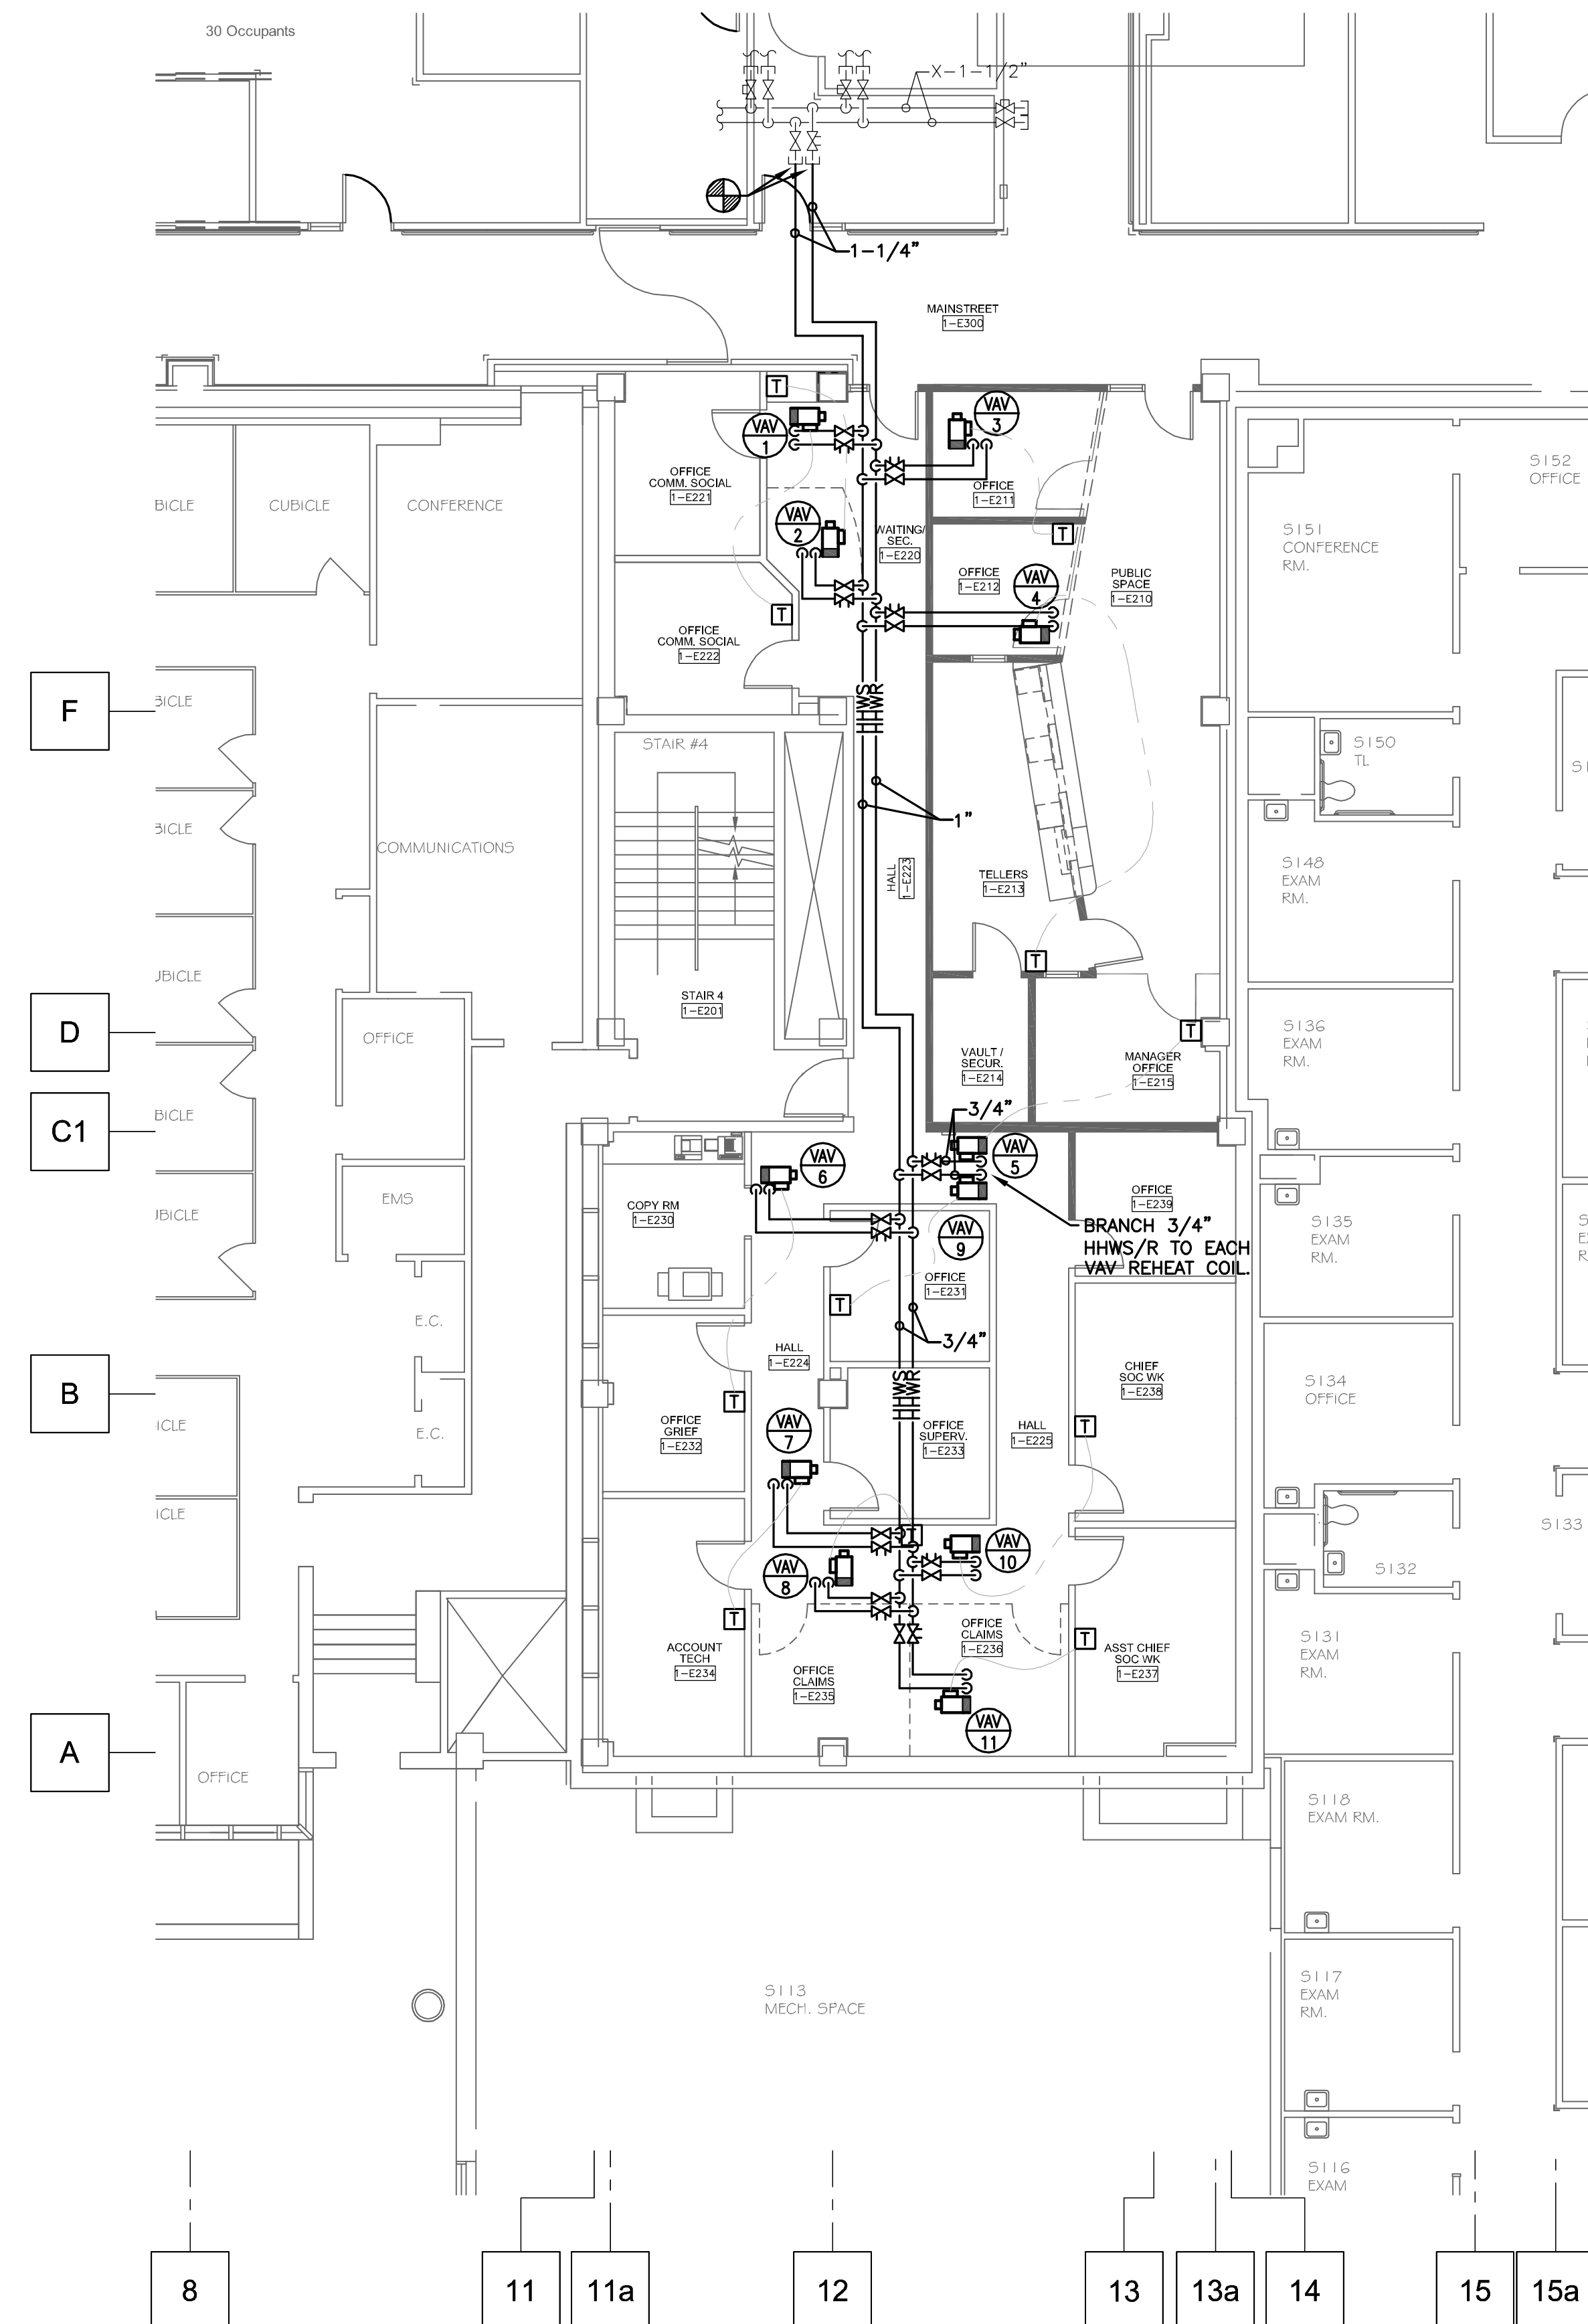PARTIAL FIRST FLOOR  
HVAC PIPING PLAN  
SCALE: 1/8" = 10'

Final Bid Set Documents Revisions:		4-27-12 Date		CONSULTANTS:		FREDRICK, FREDRICK & HELLER ENGINEERS, INC. 672 EAST ROYALTON ROAD BROADVIEW HTS., OHIO 44147 TEL: (440) 546-0606 FAX: (440) 546-0606		ARCHITECT:		Perspectus architecture 13212 Shaker Square Suite 204 Cleveland, Ohio 44120 P. 216.752.1800 F. 216.752.3833		Drawing Title PARTIAL FIRST FLOOR HVAC PIPING PLANS		Project Title SOCIAL WORK AND HBPC OFFICE RENOVATION		Project Number 541-12-104		Office of Facilities Management	
Approved: Project Director		Date 04-27-12		Checked LDH		Drawn SEP		Location VAMC - WADE PARK		Building Number 1		Drawing Number 1-H4		Dwg. of		Department of Veterans Affairs		FULLY SPRINKLERED	